





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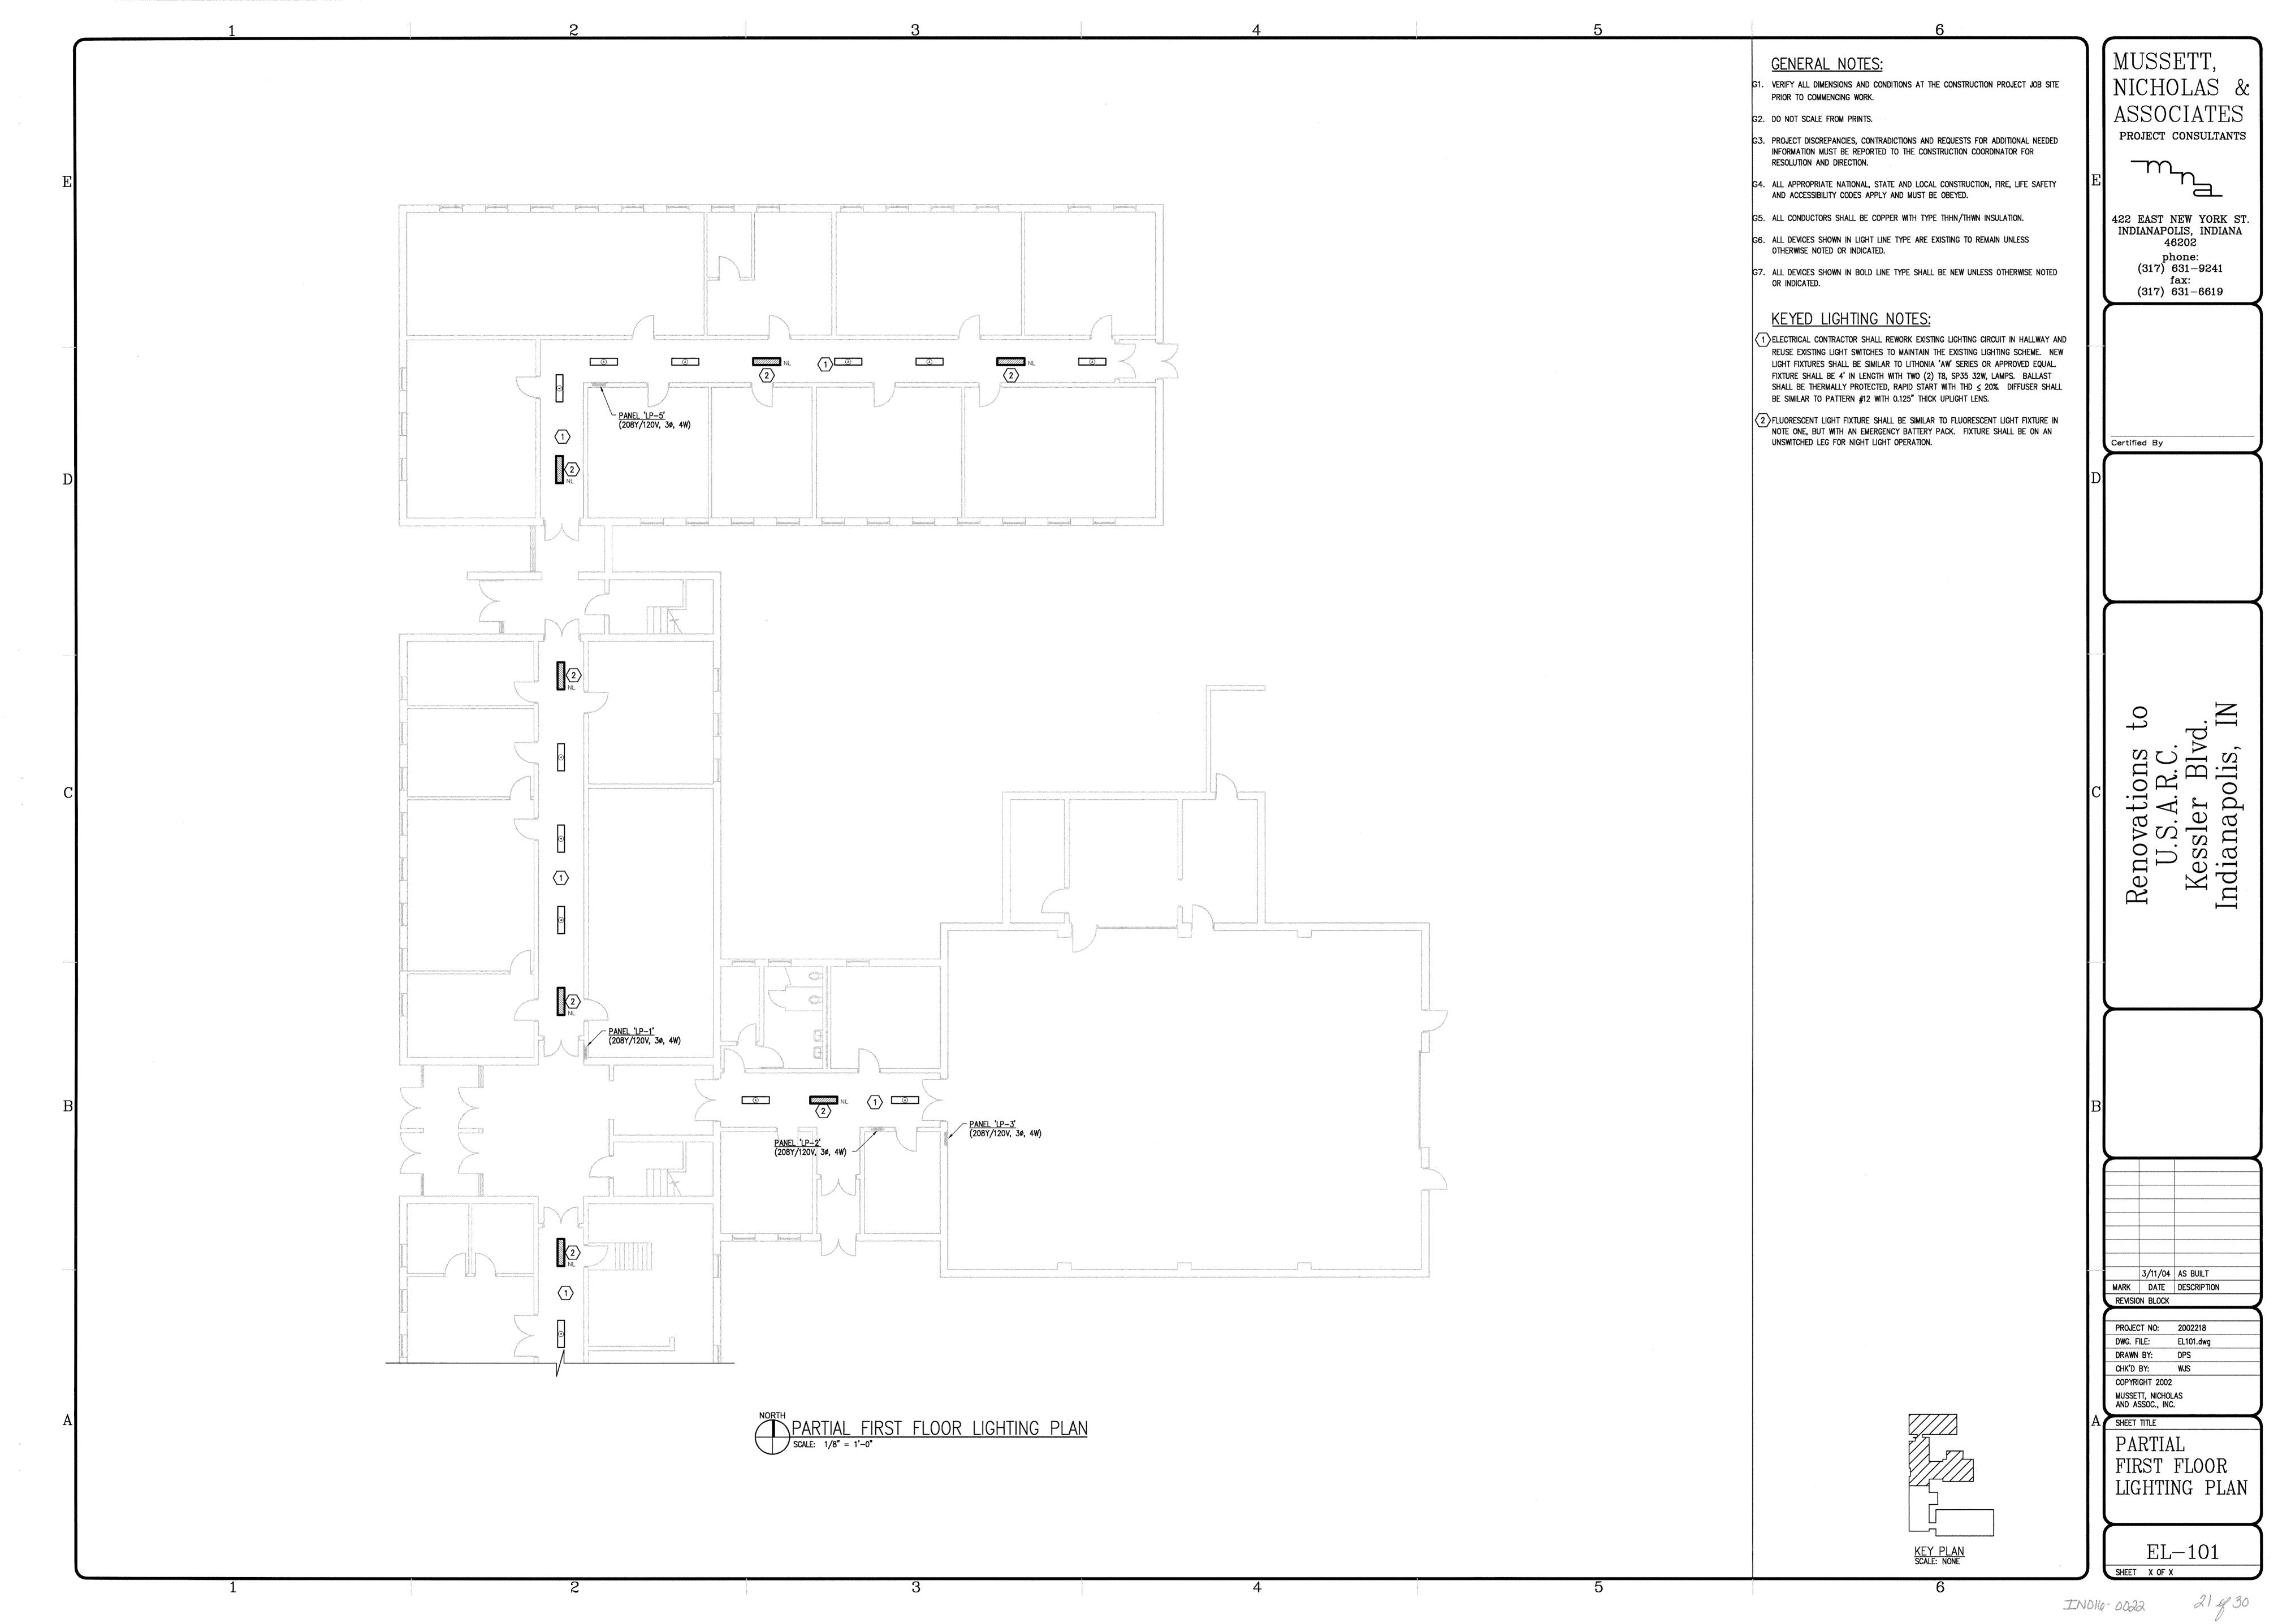



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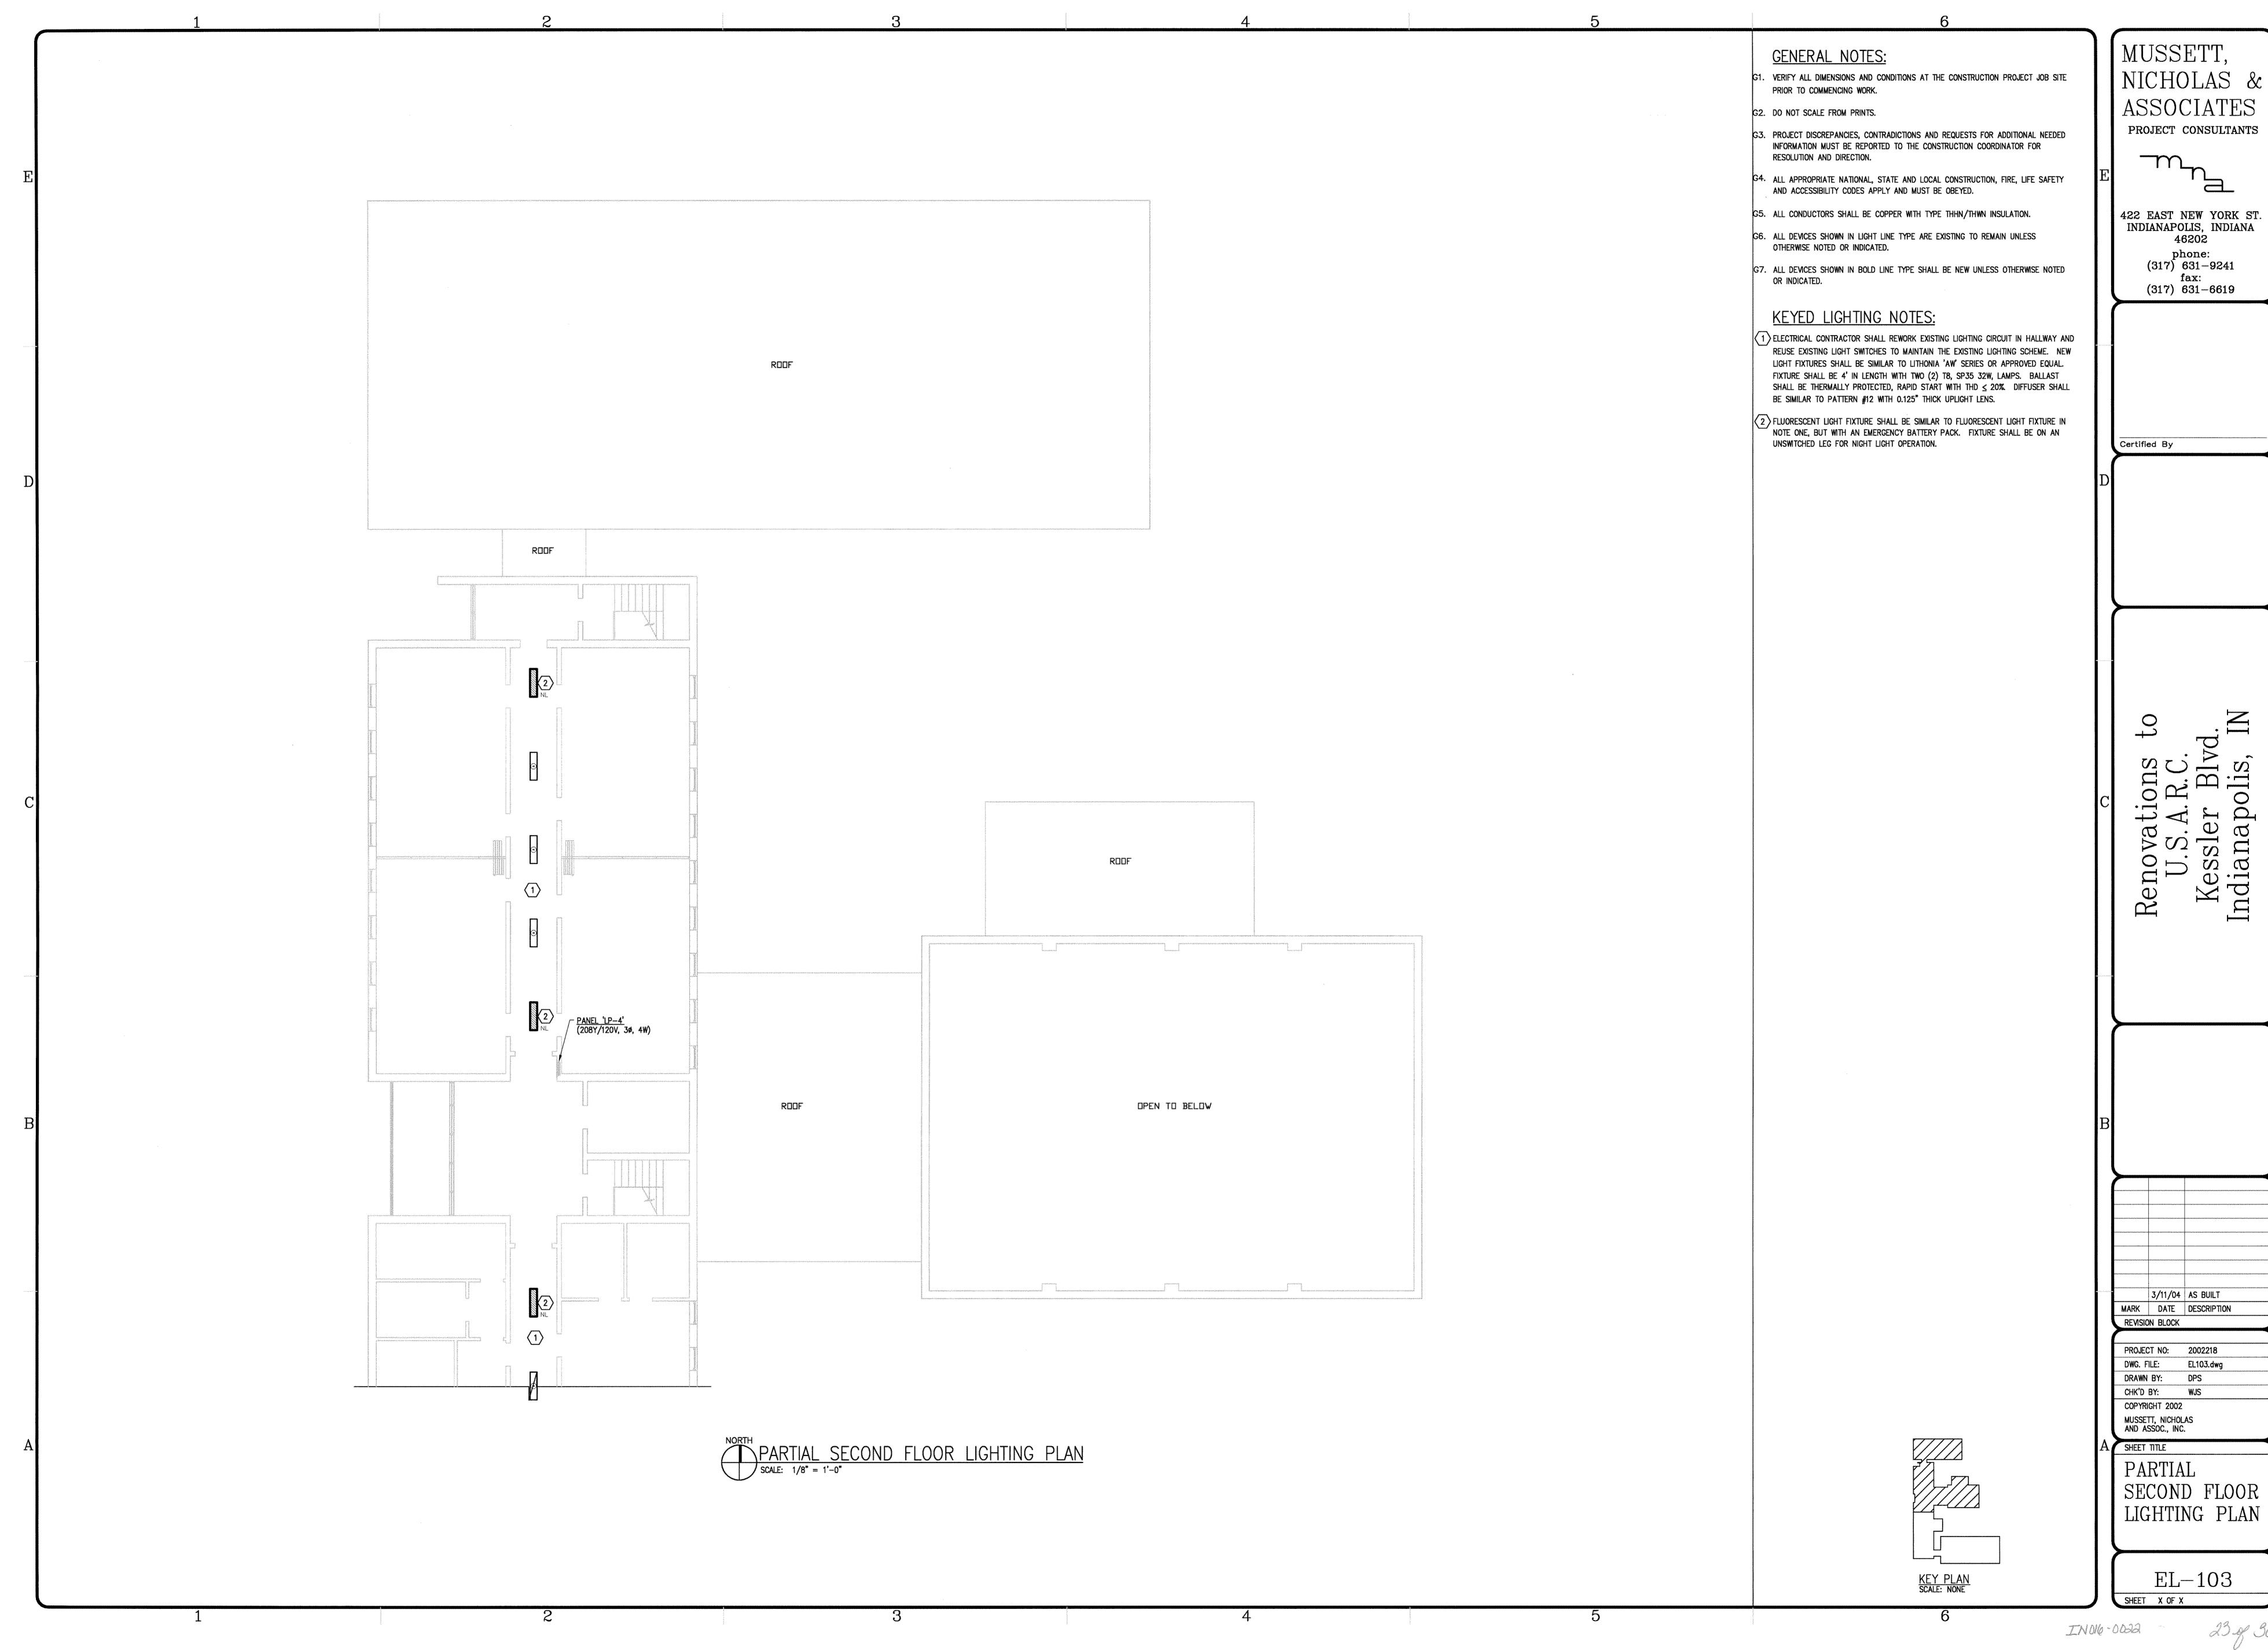


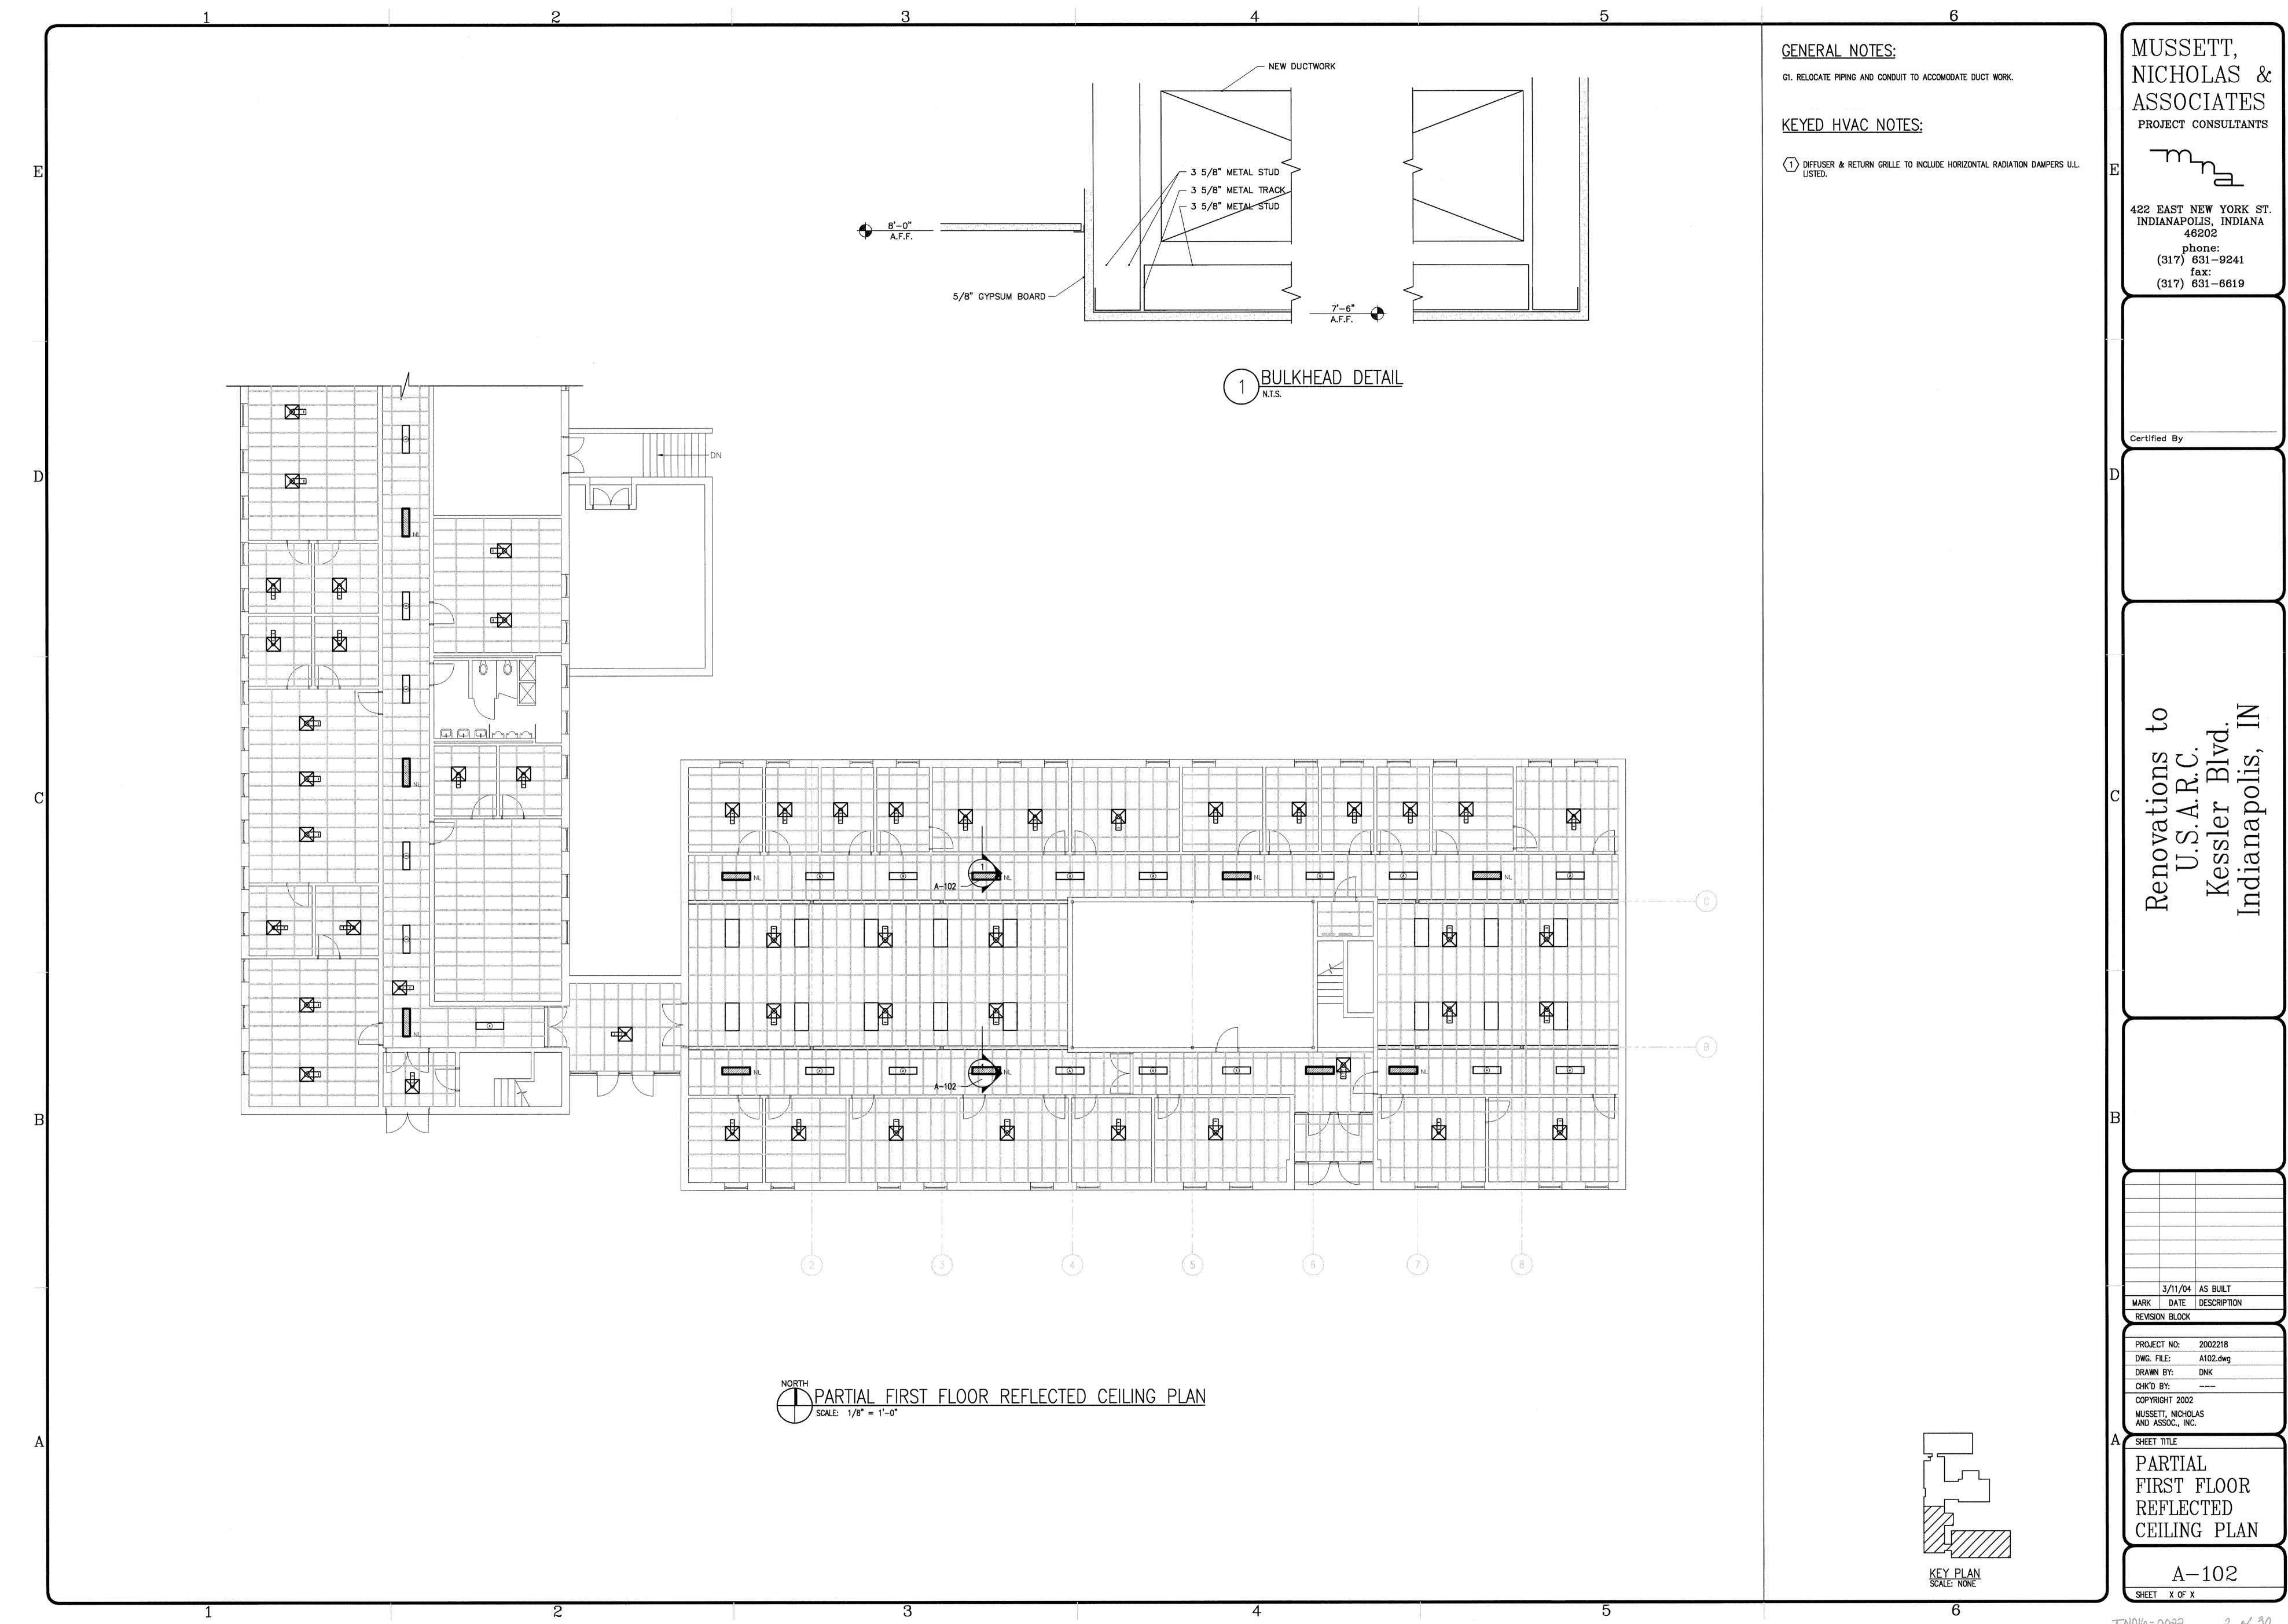

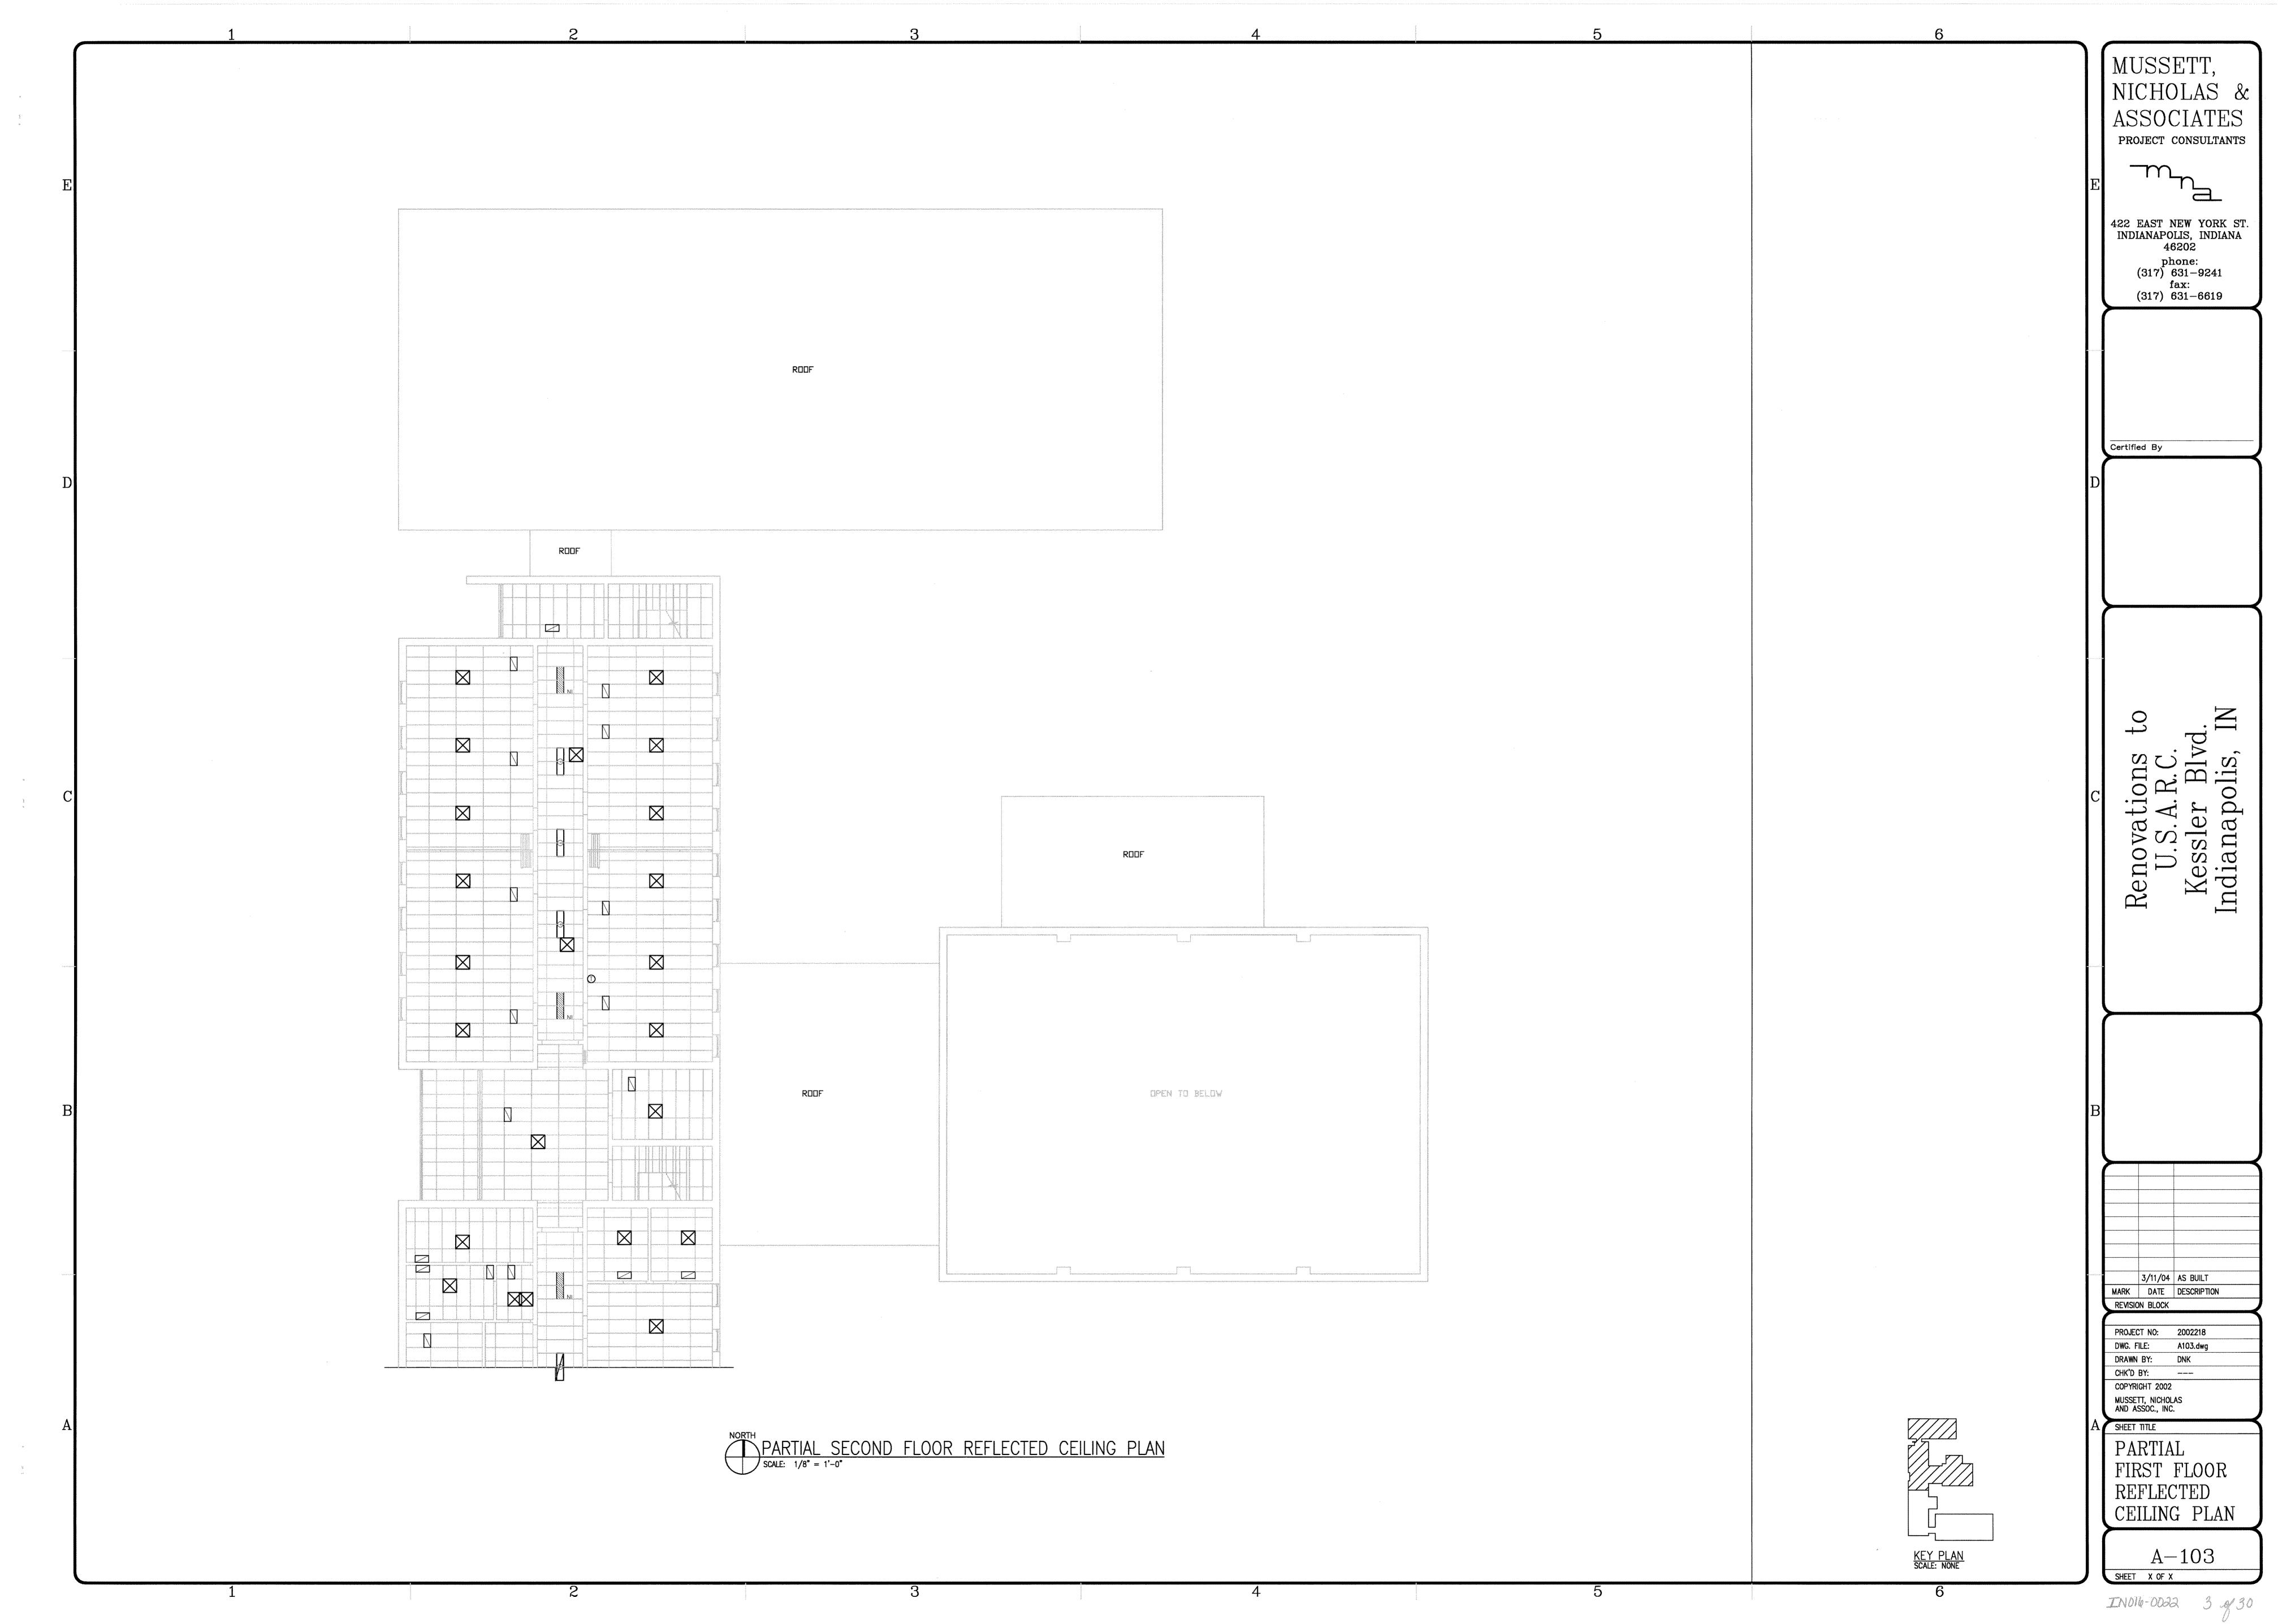


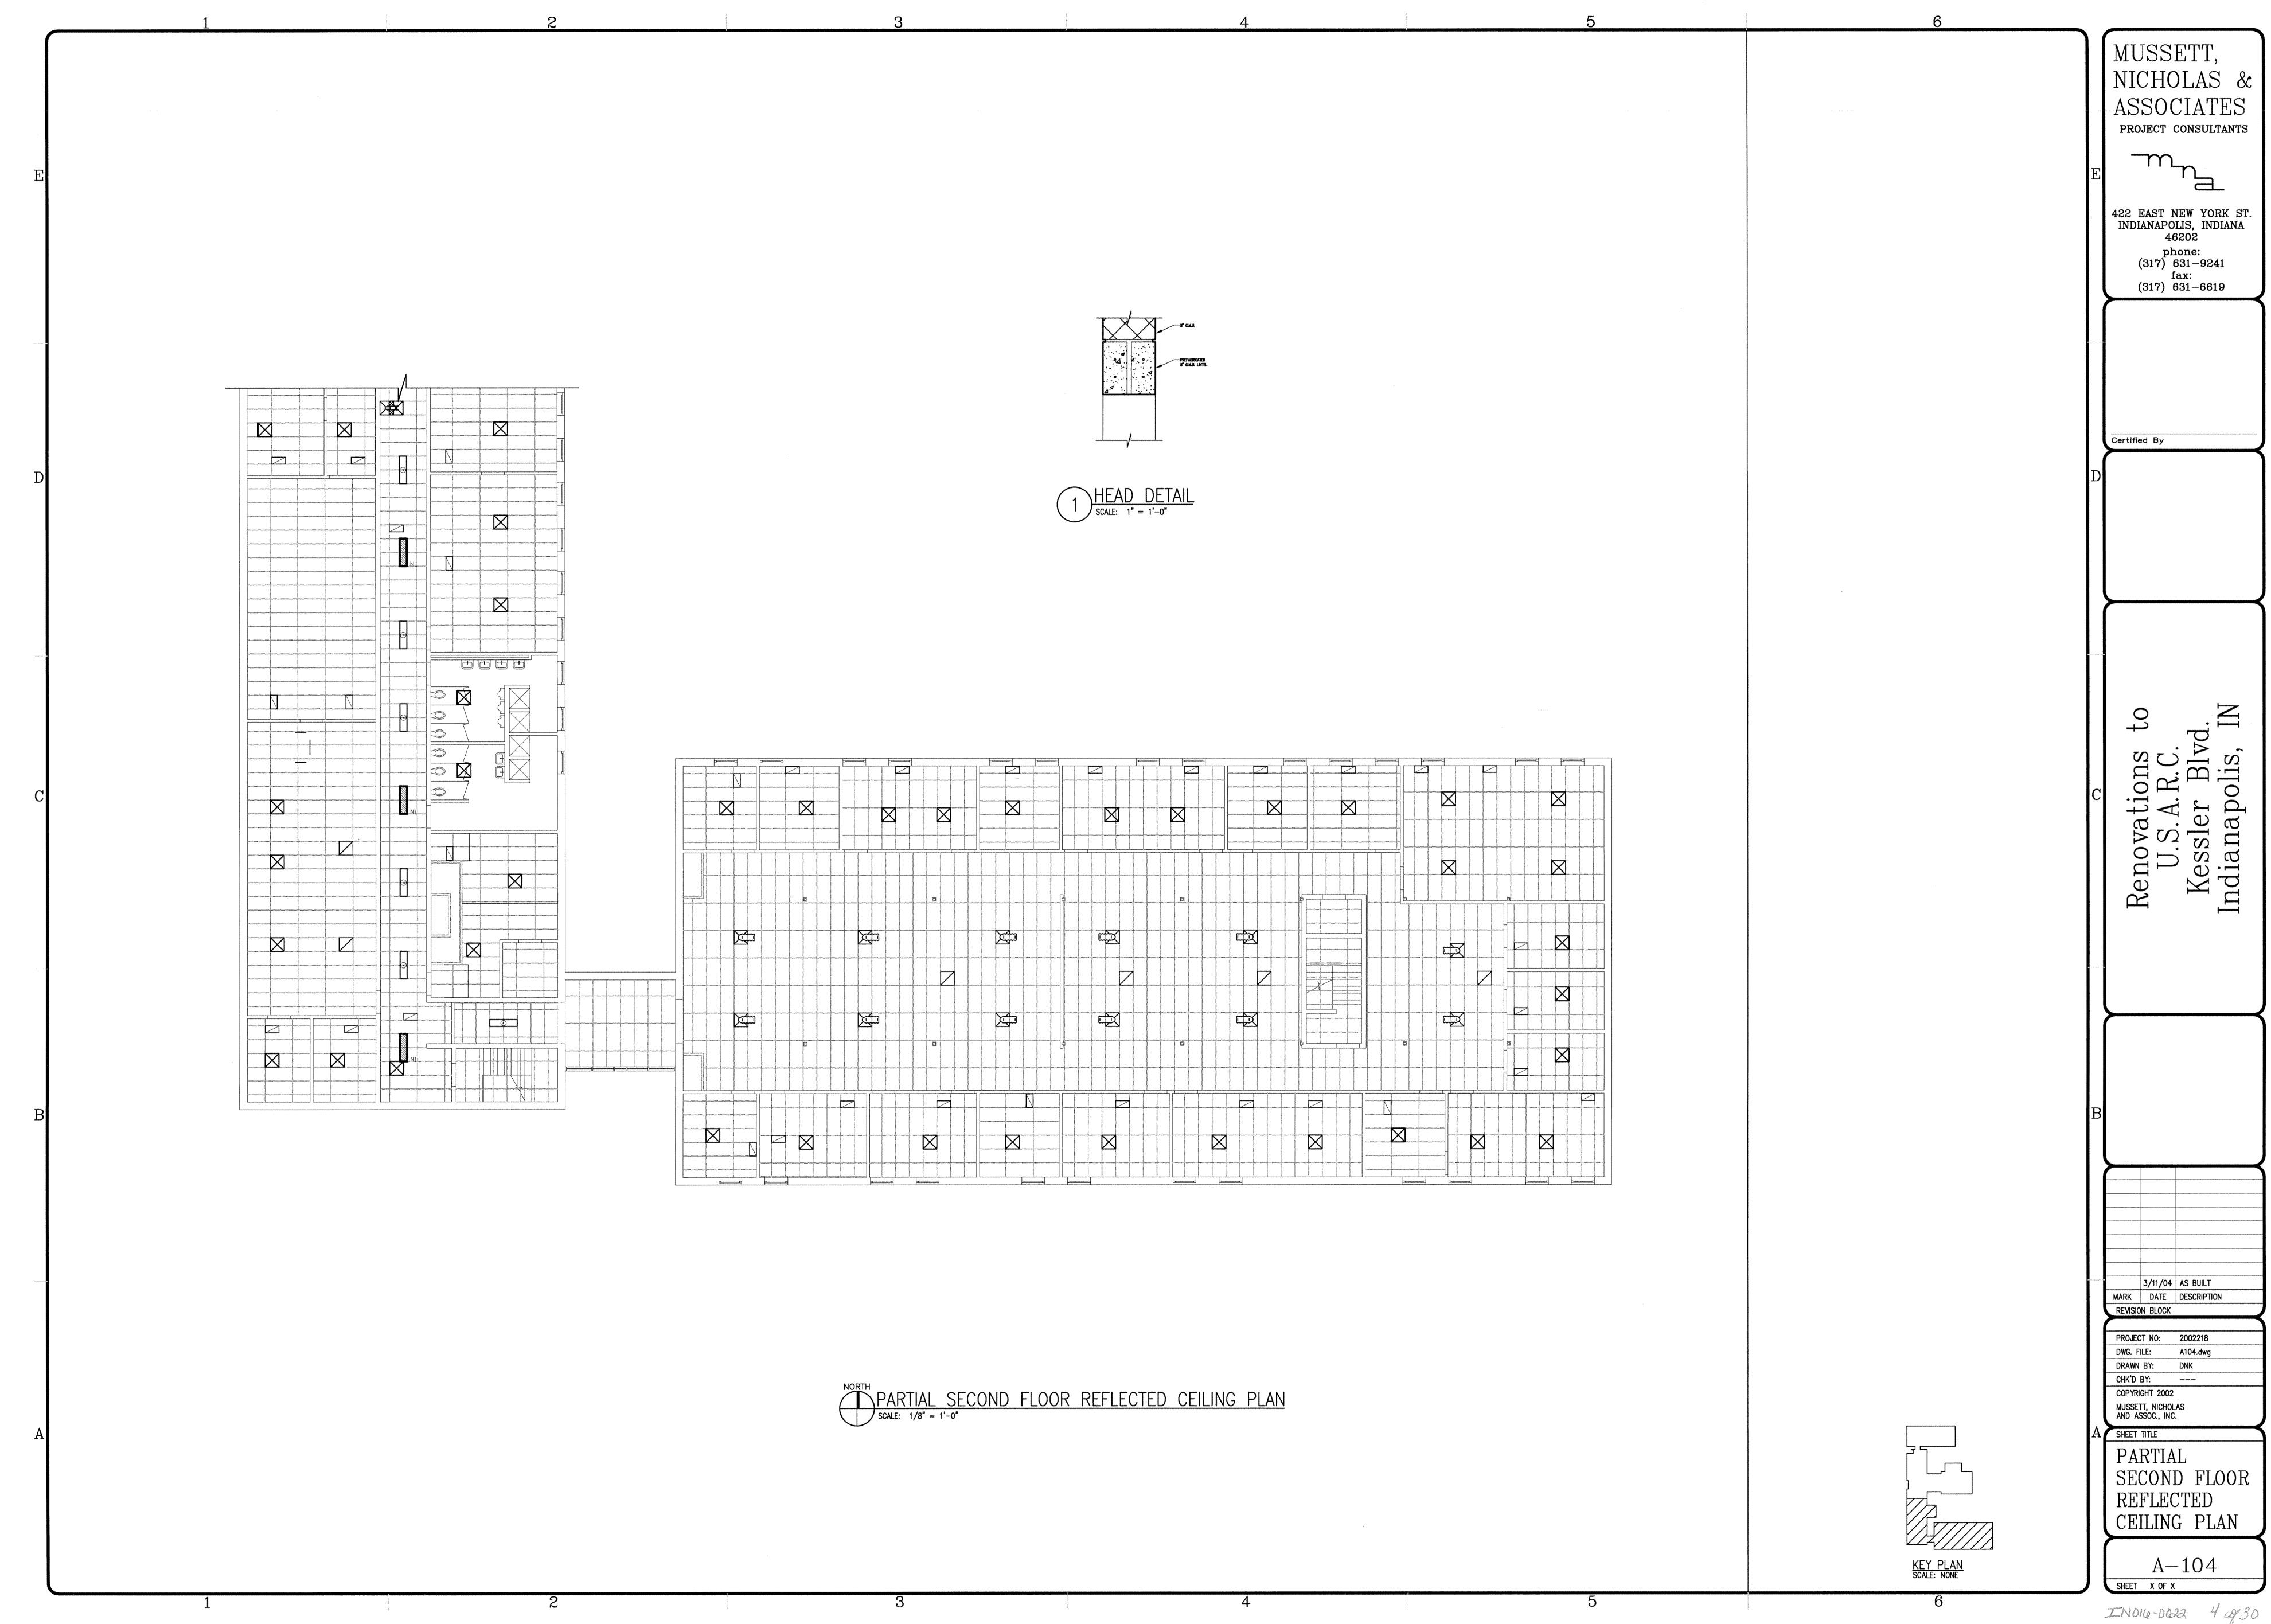


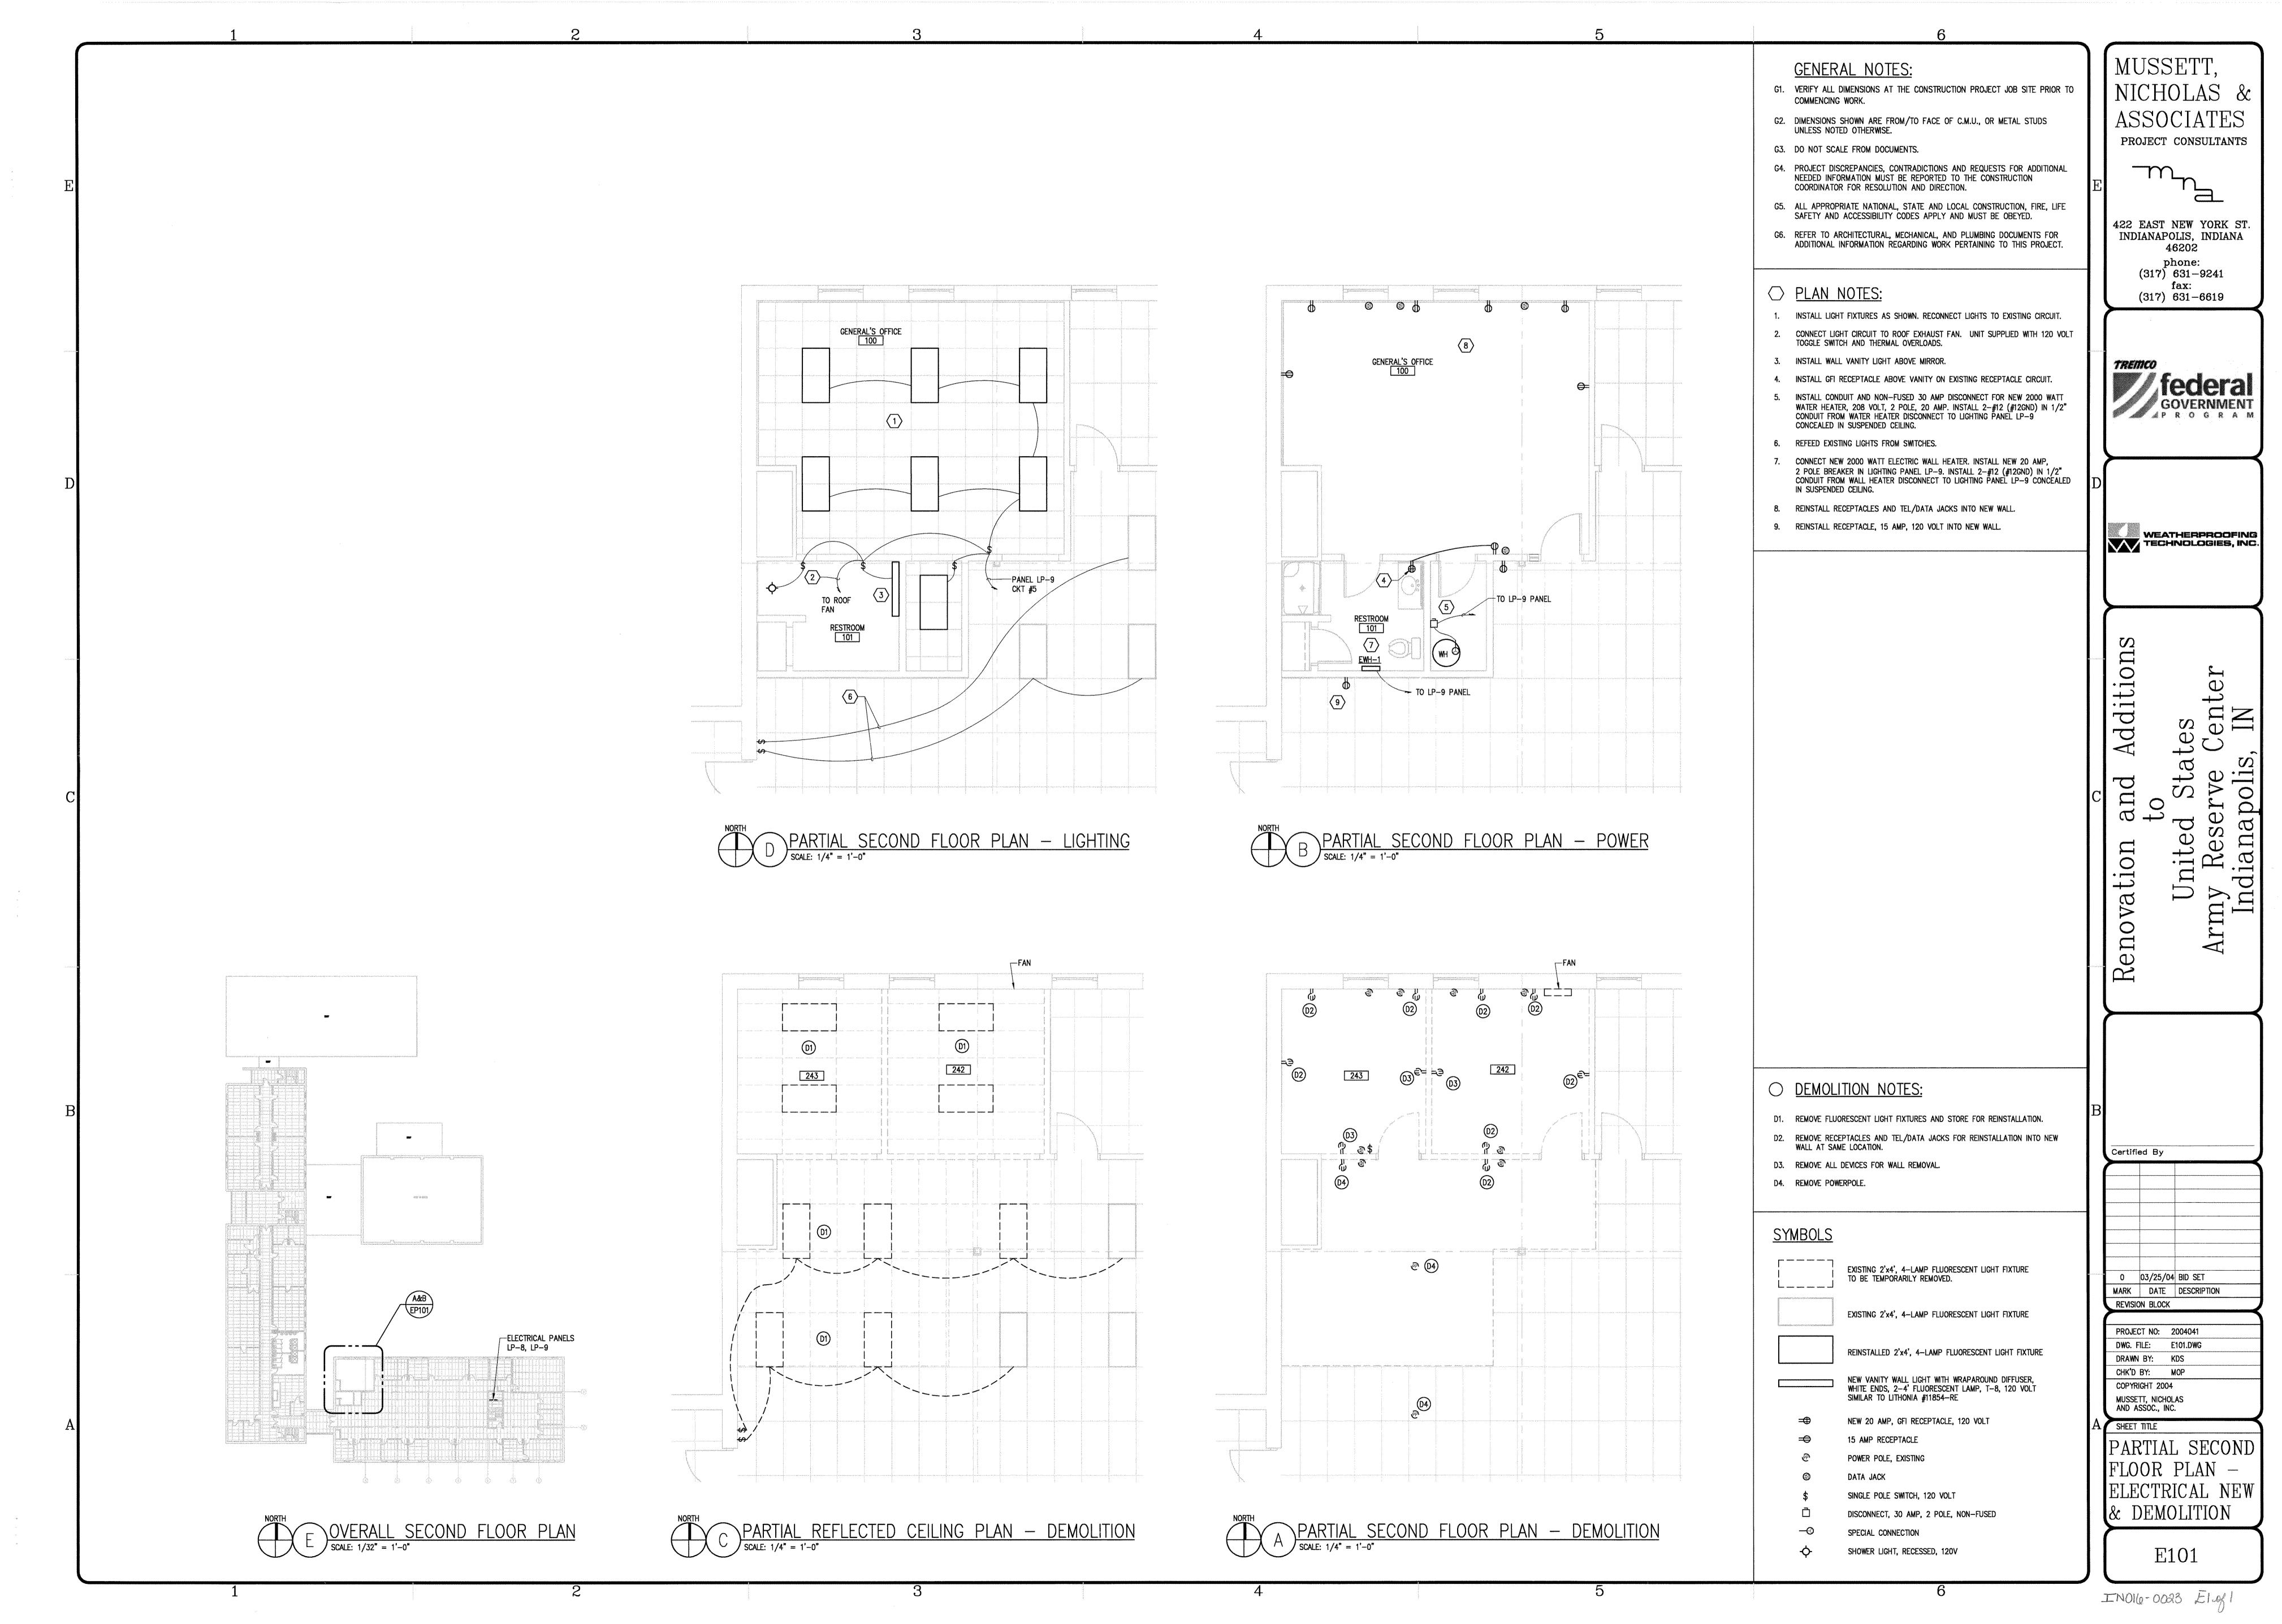


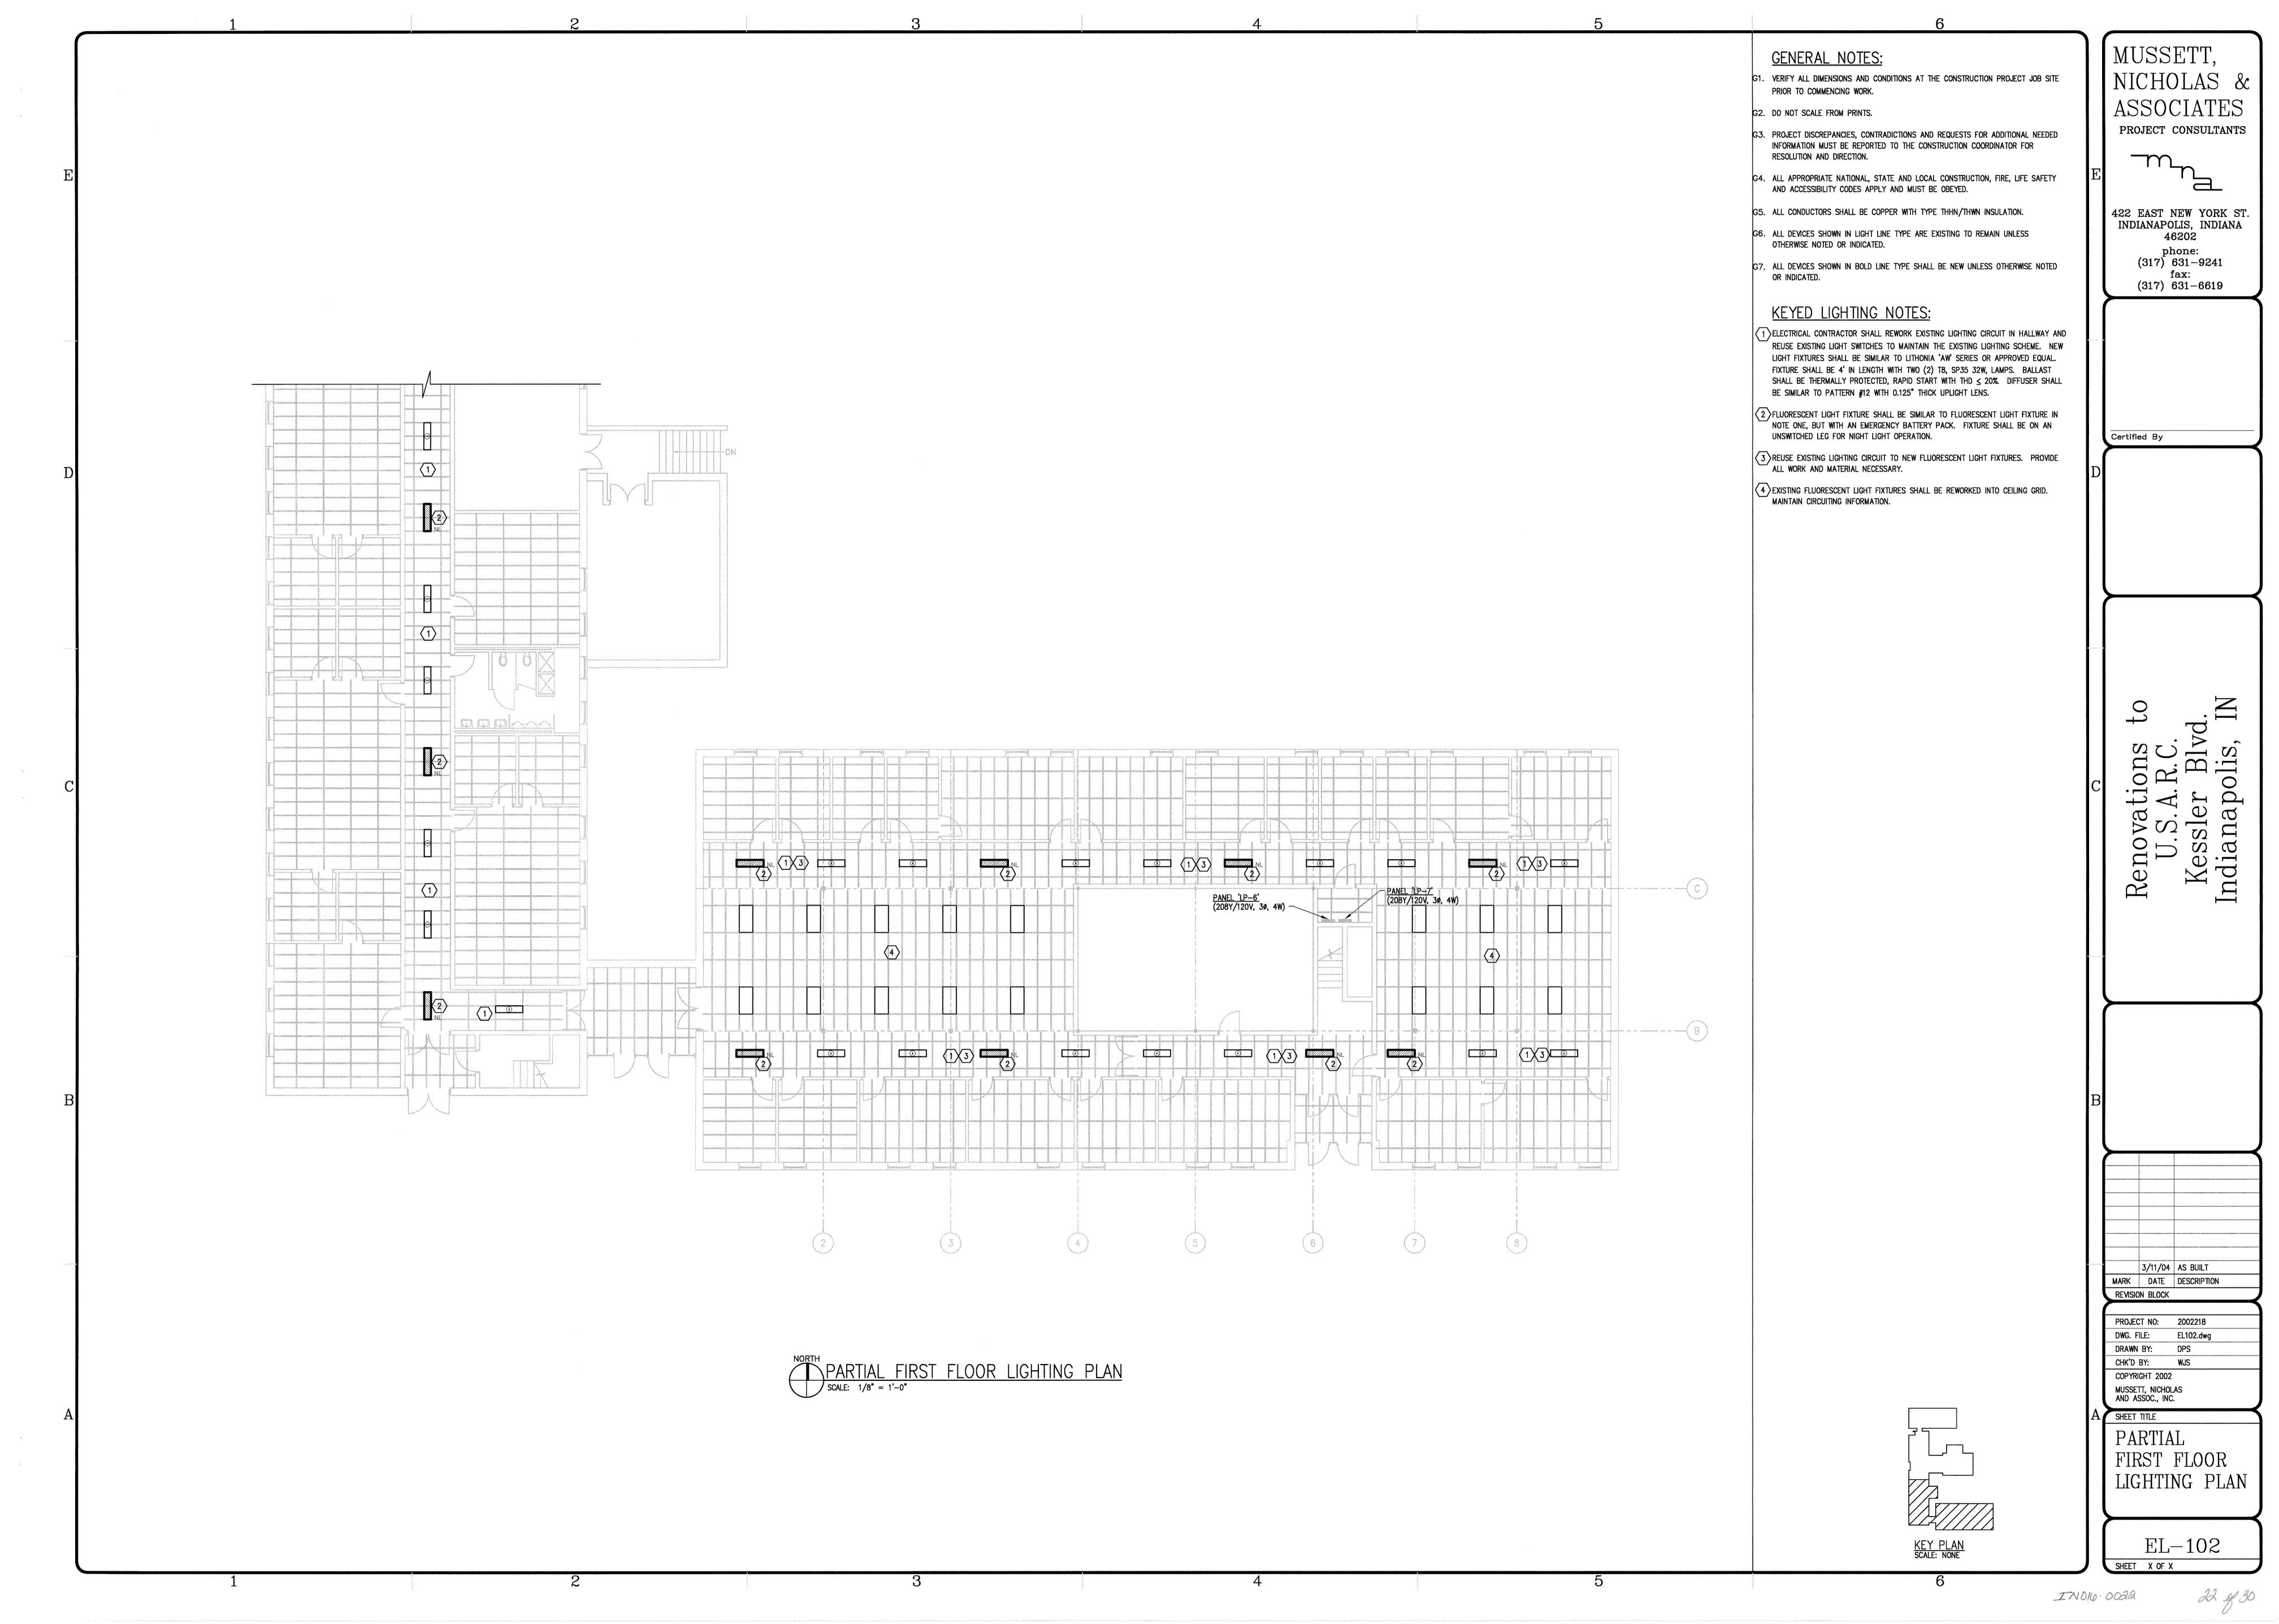



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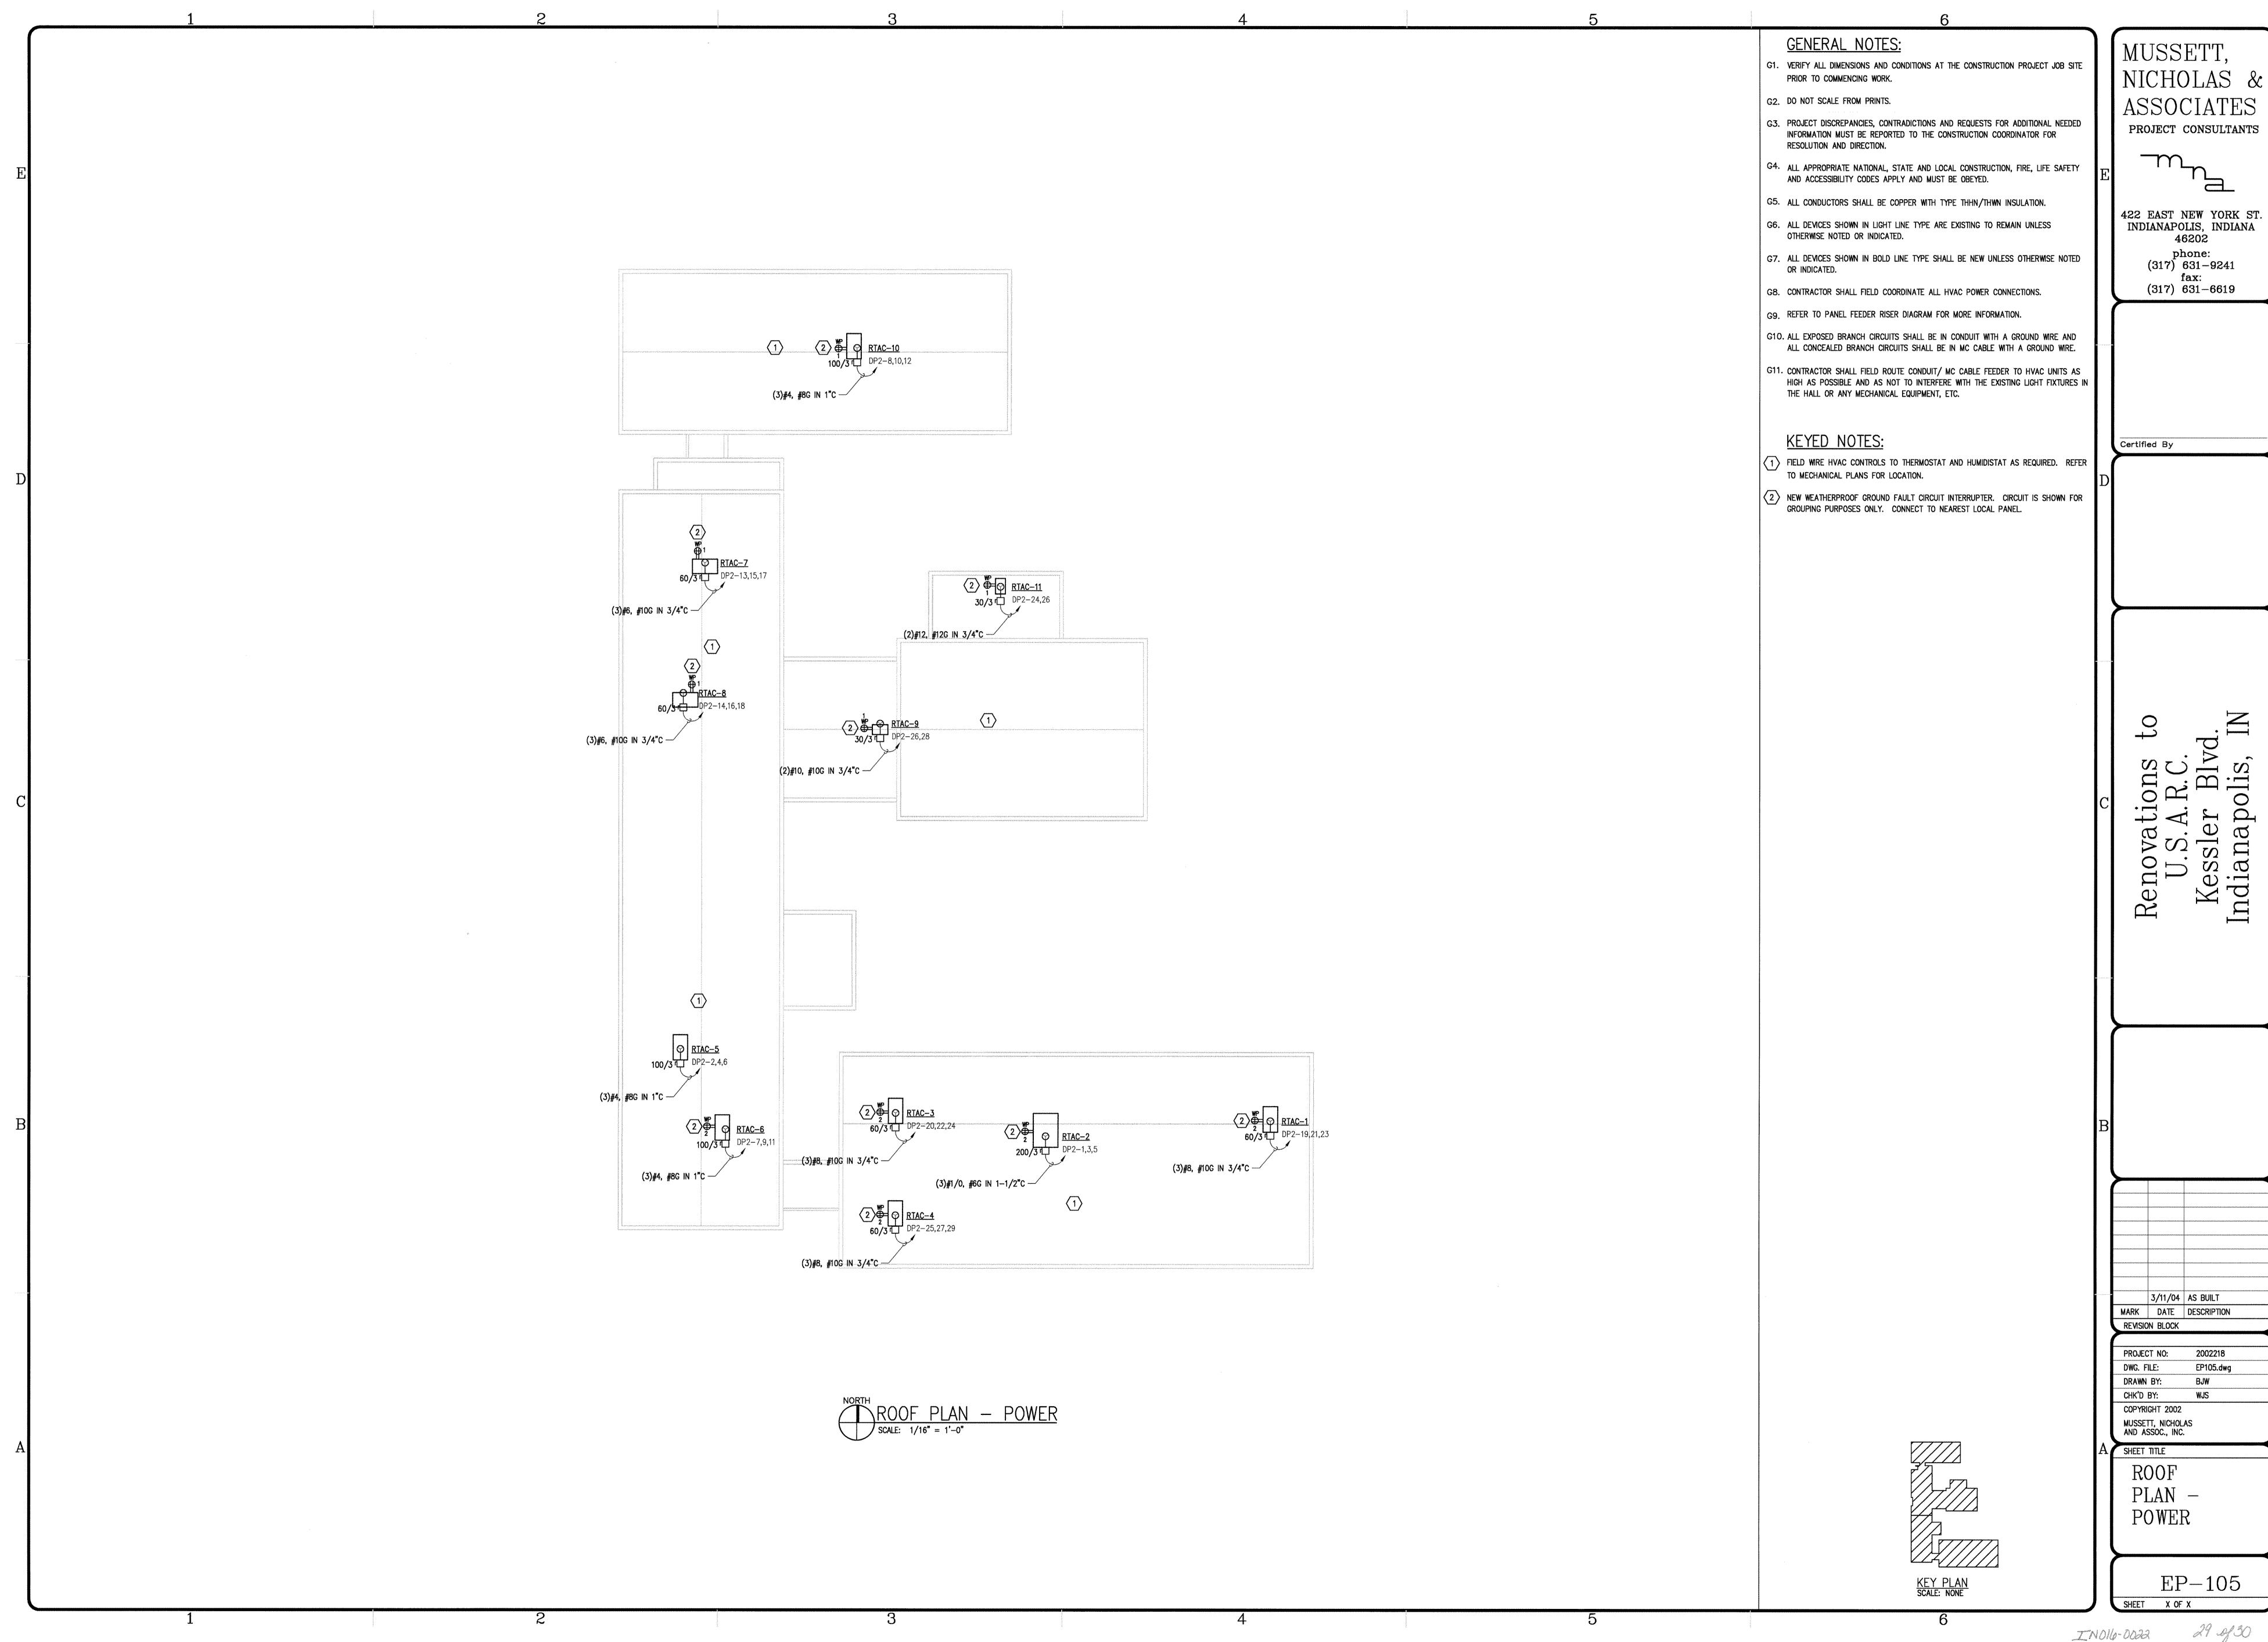


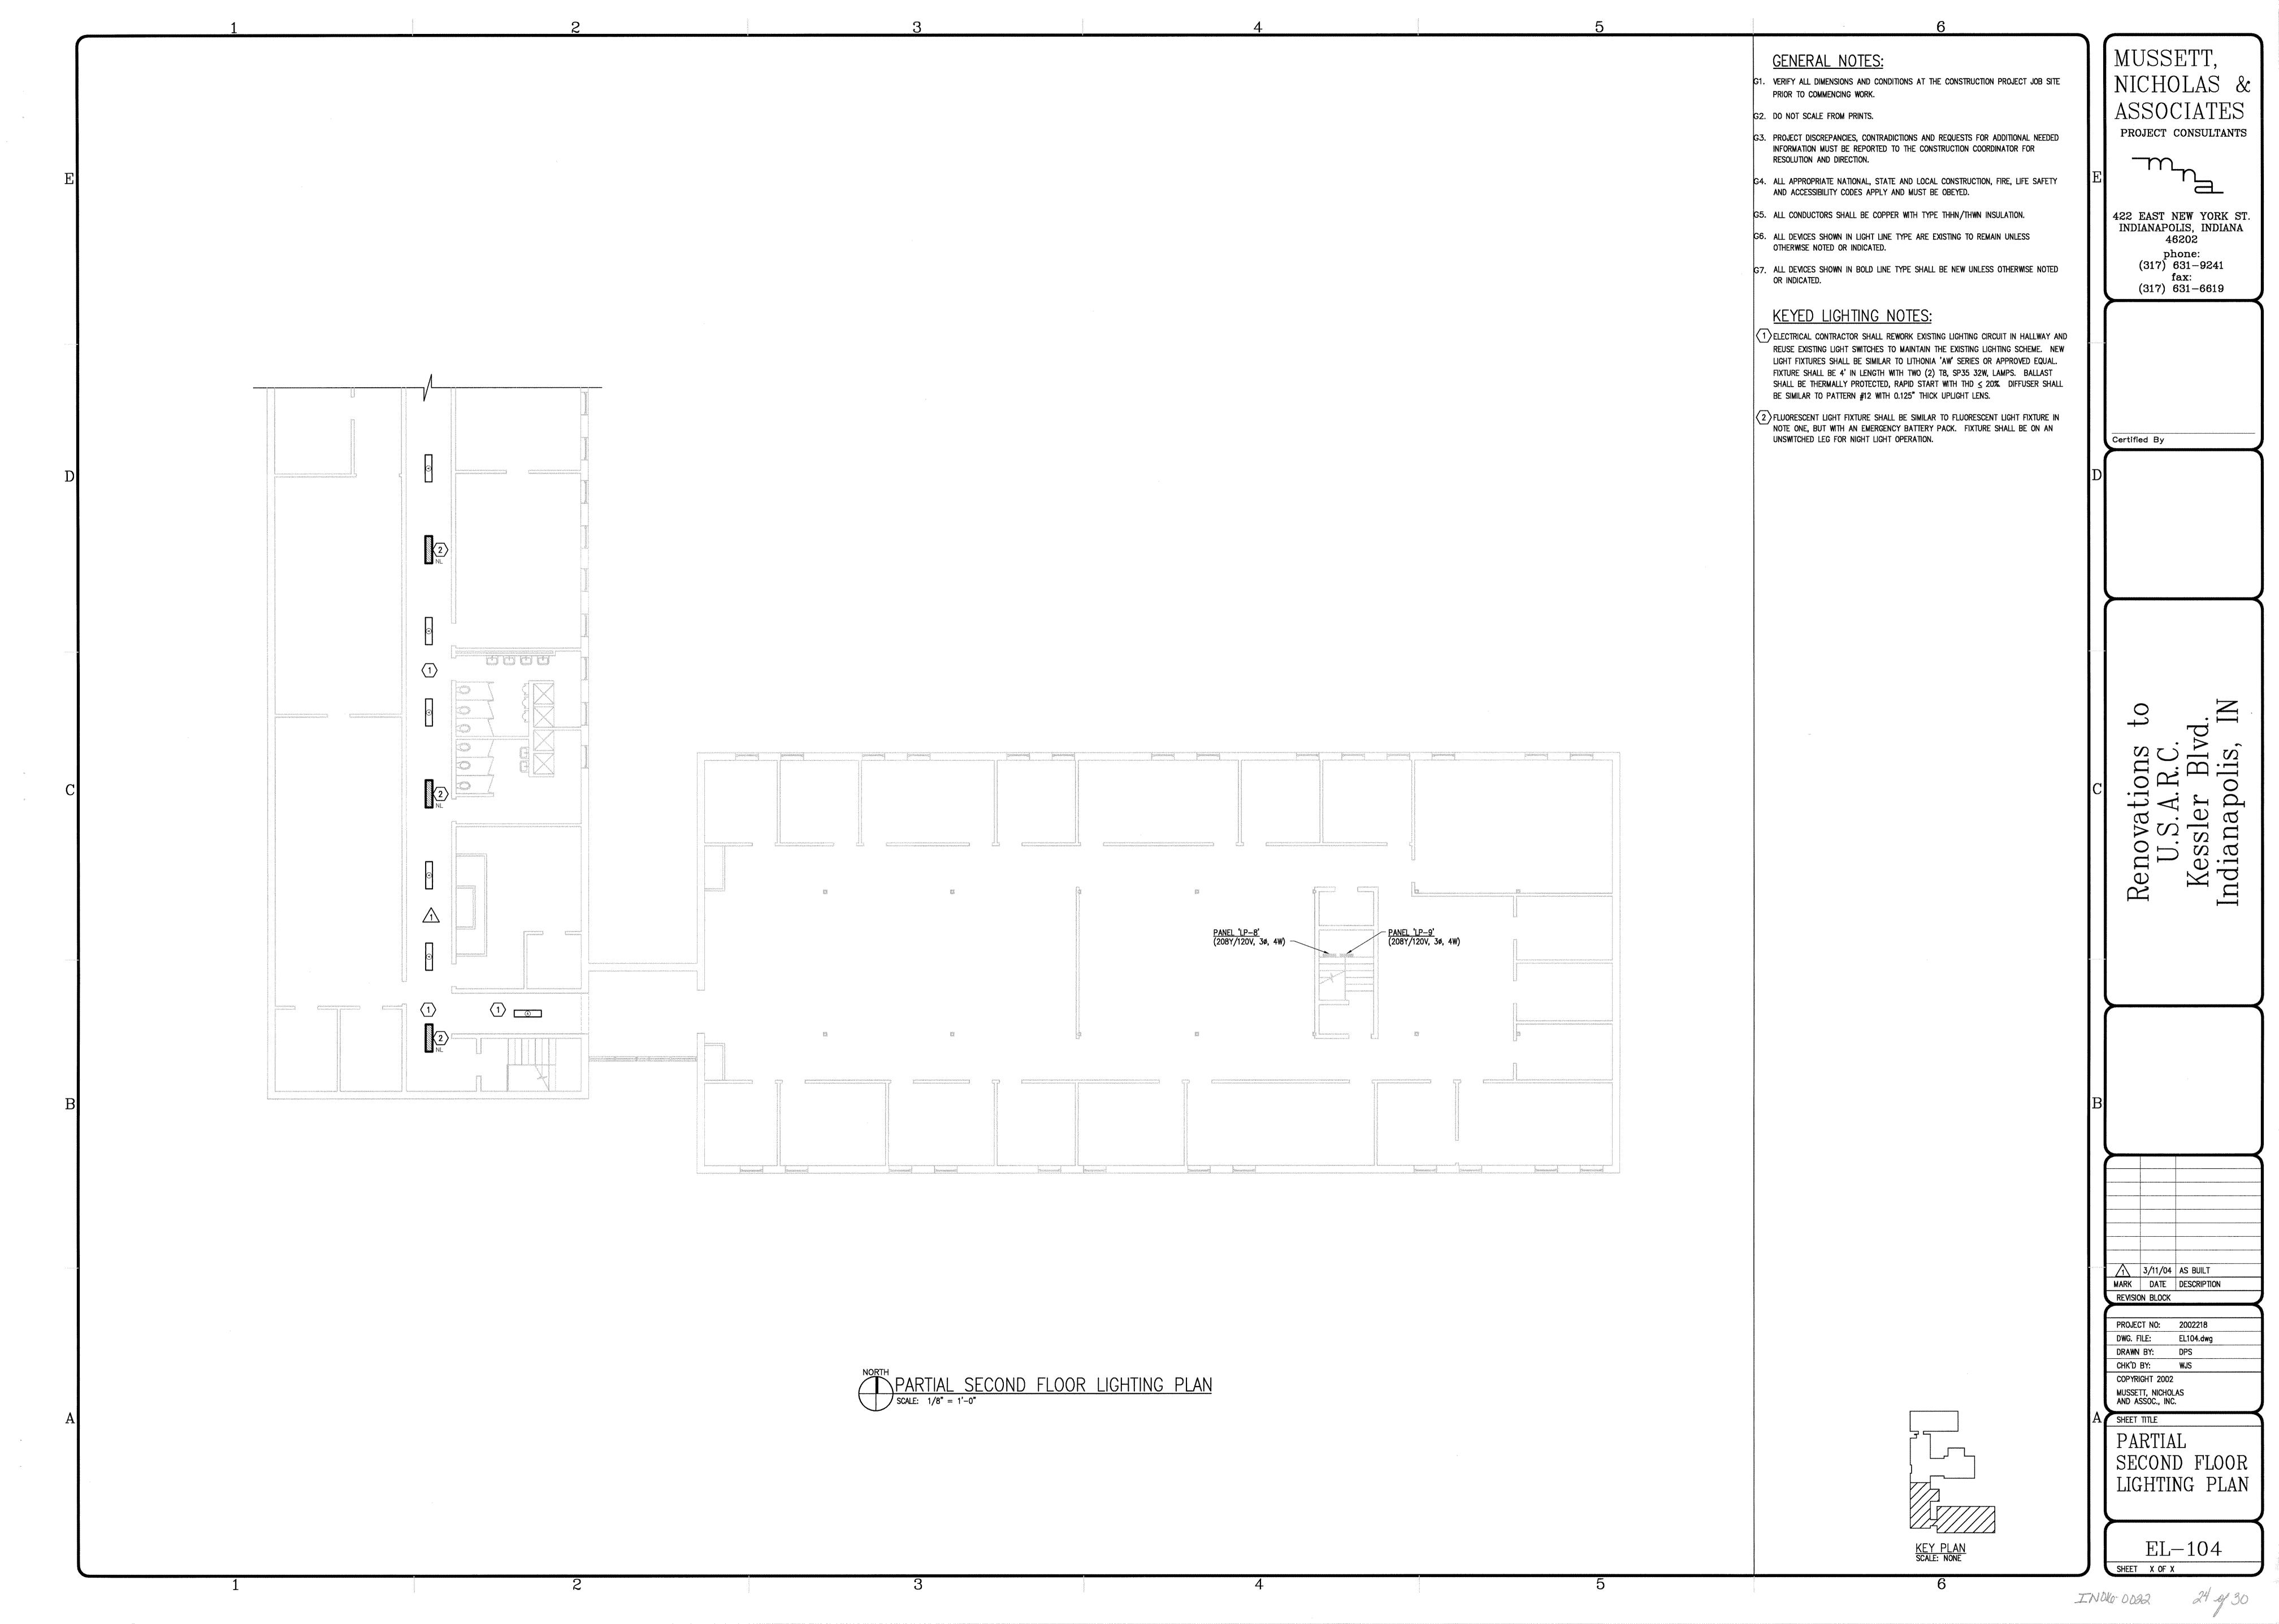


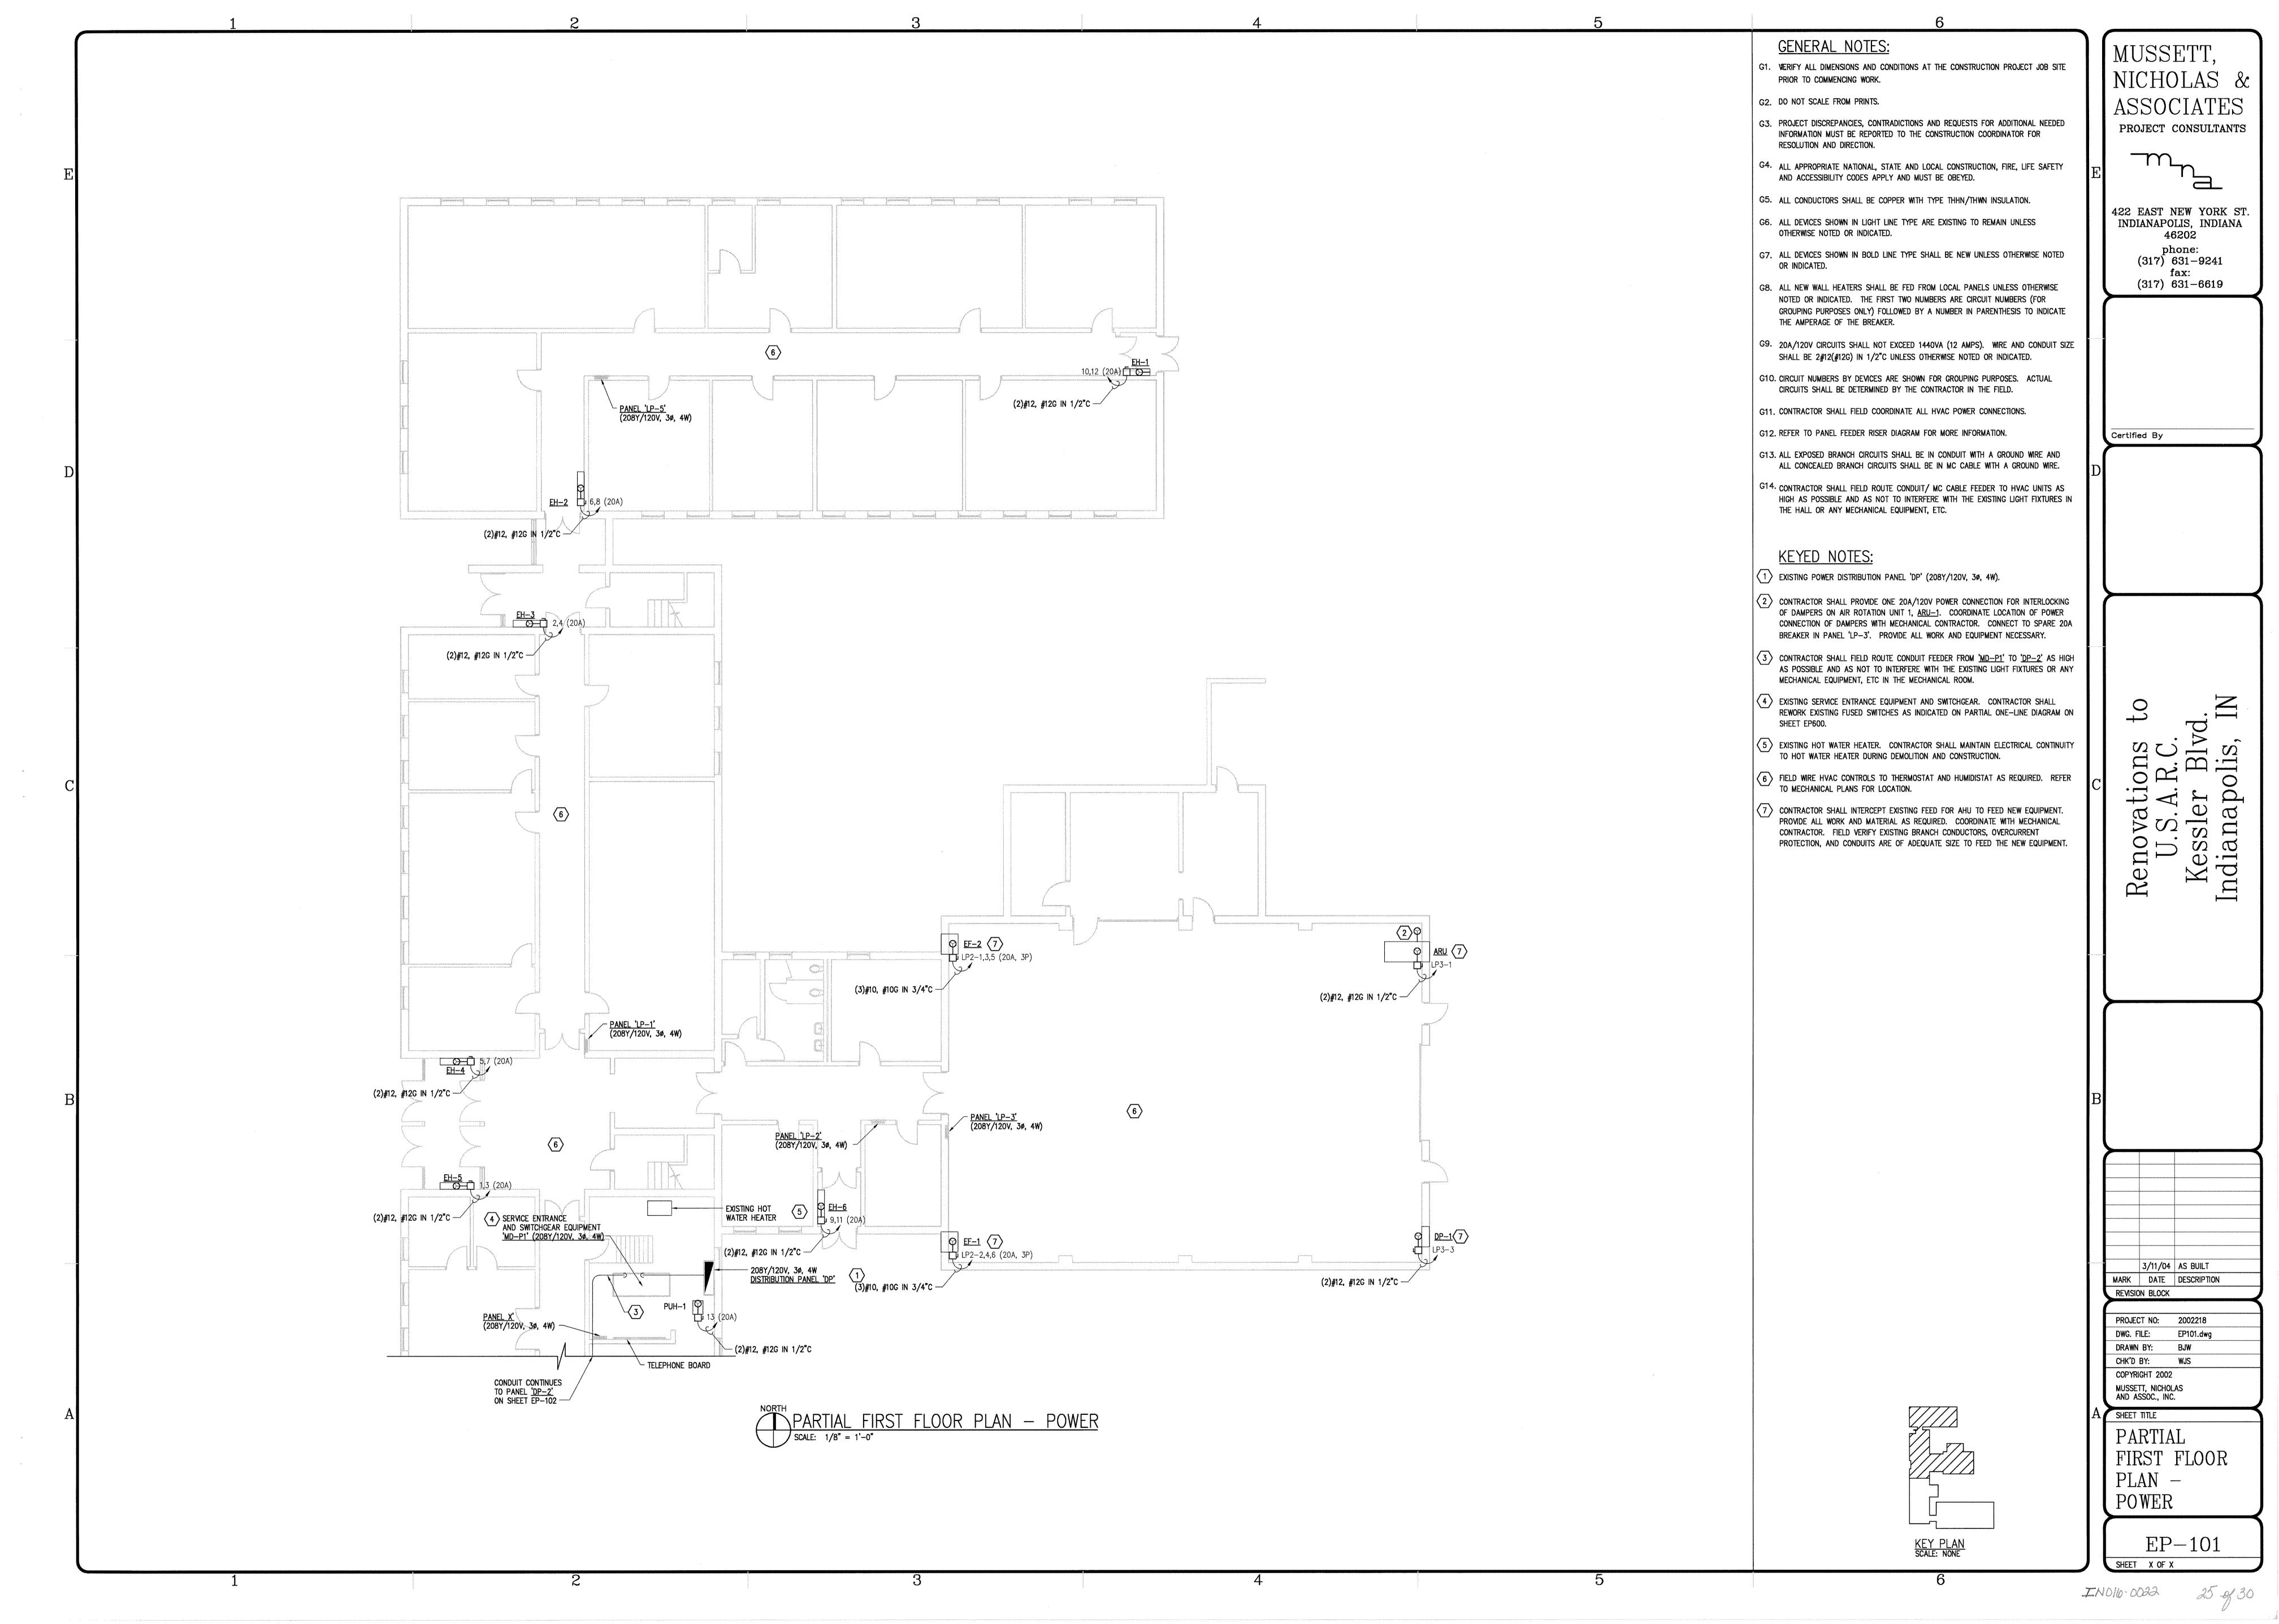

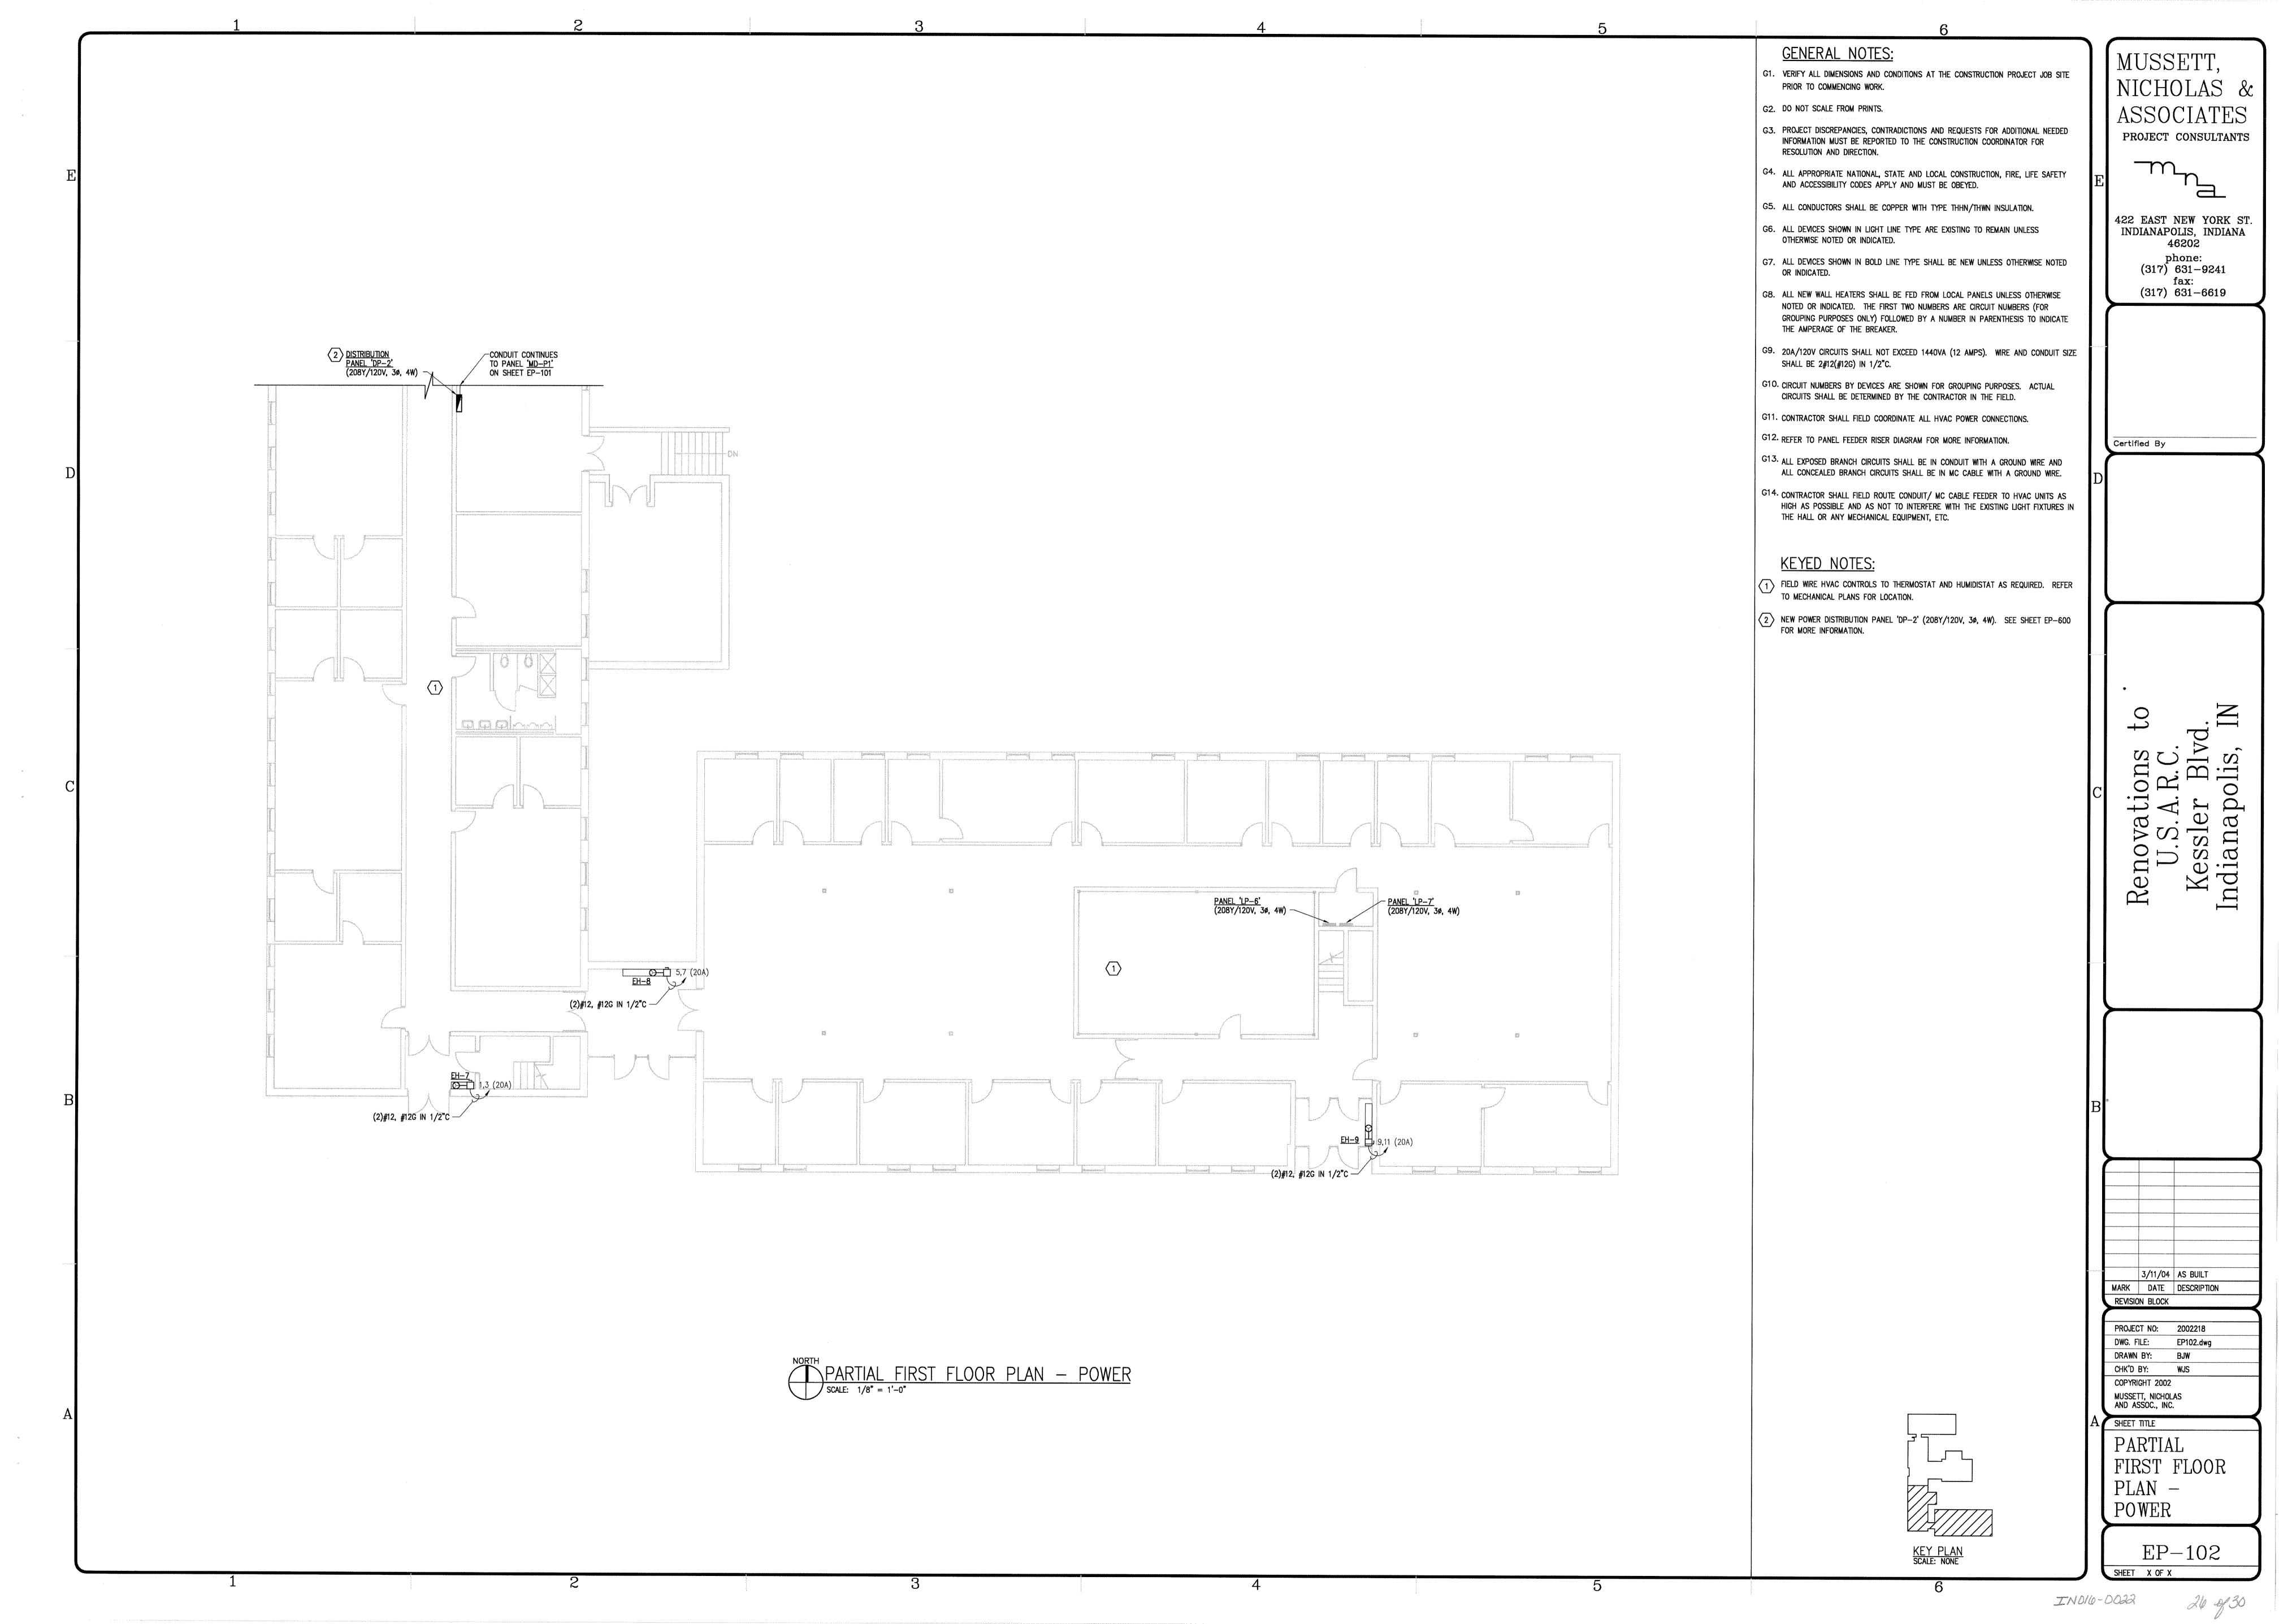


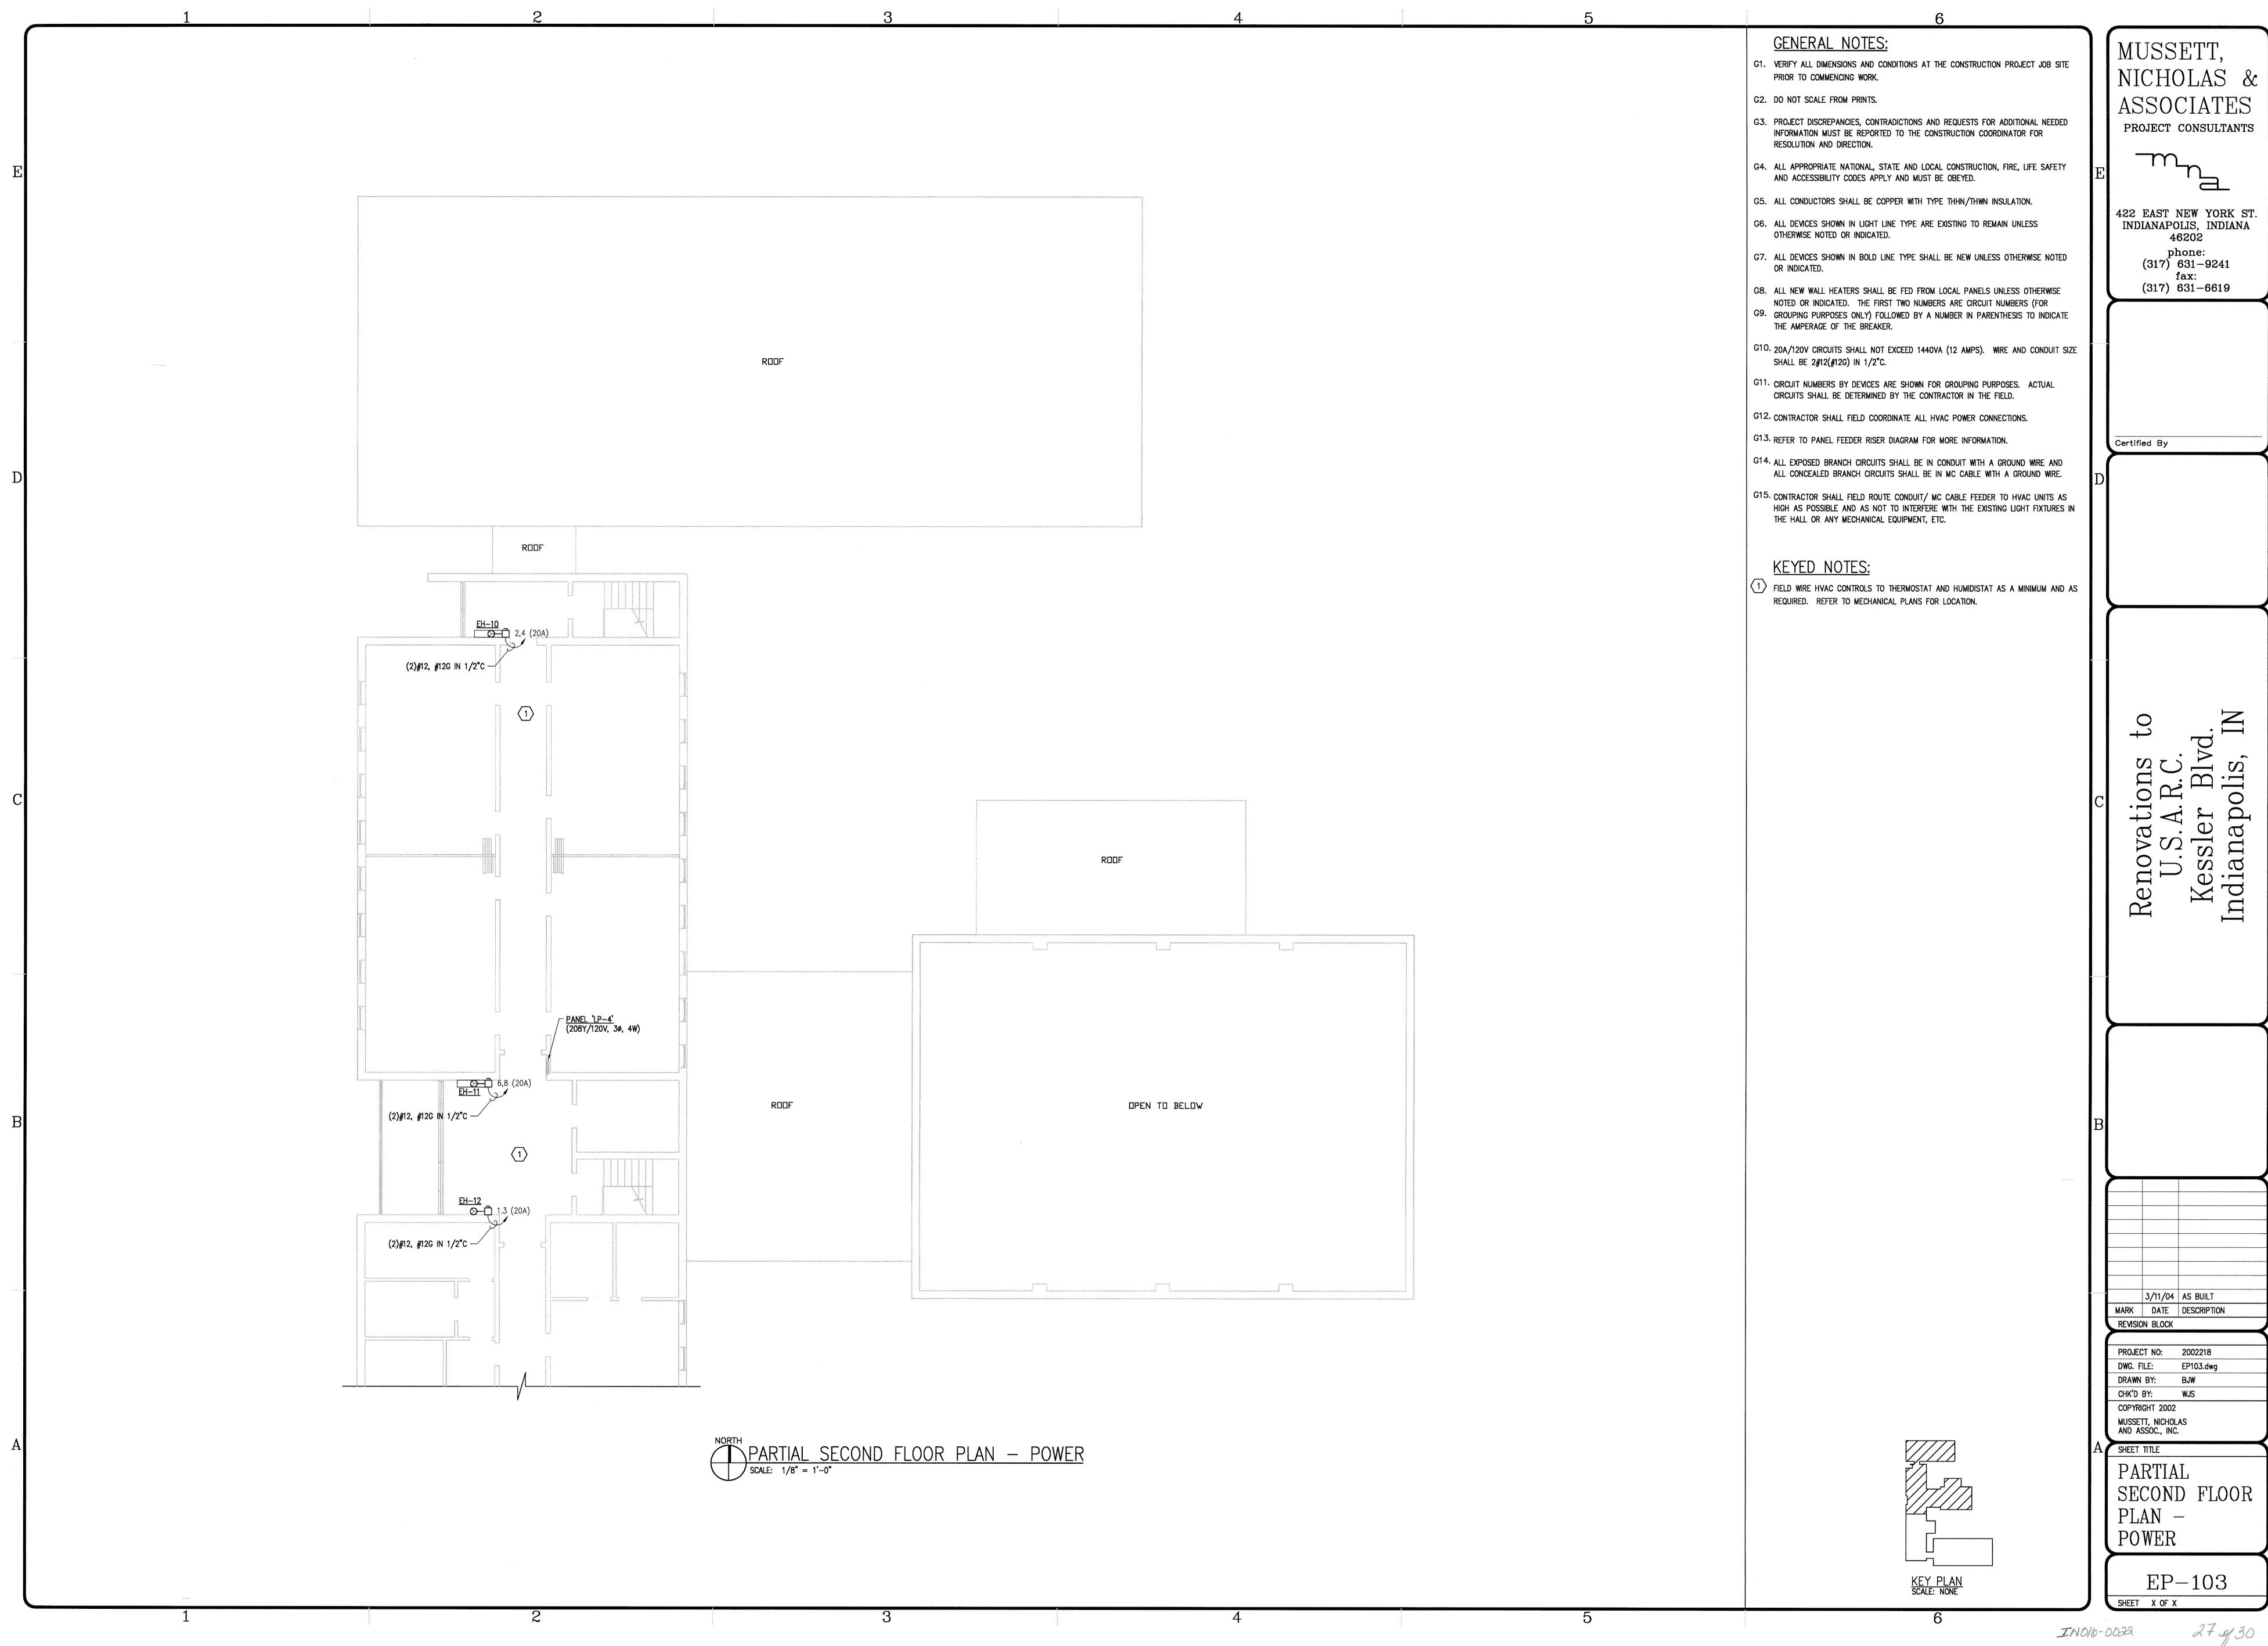

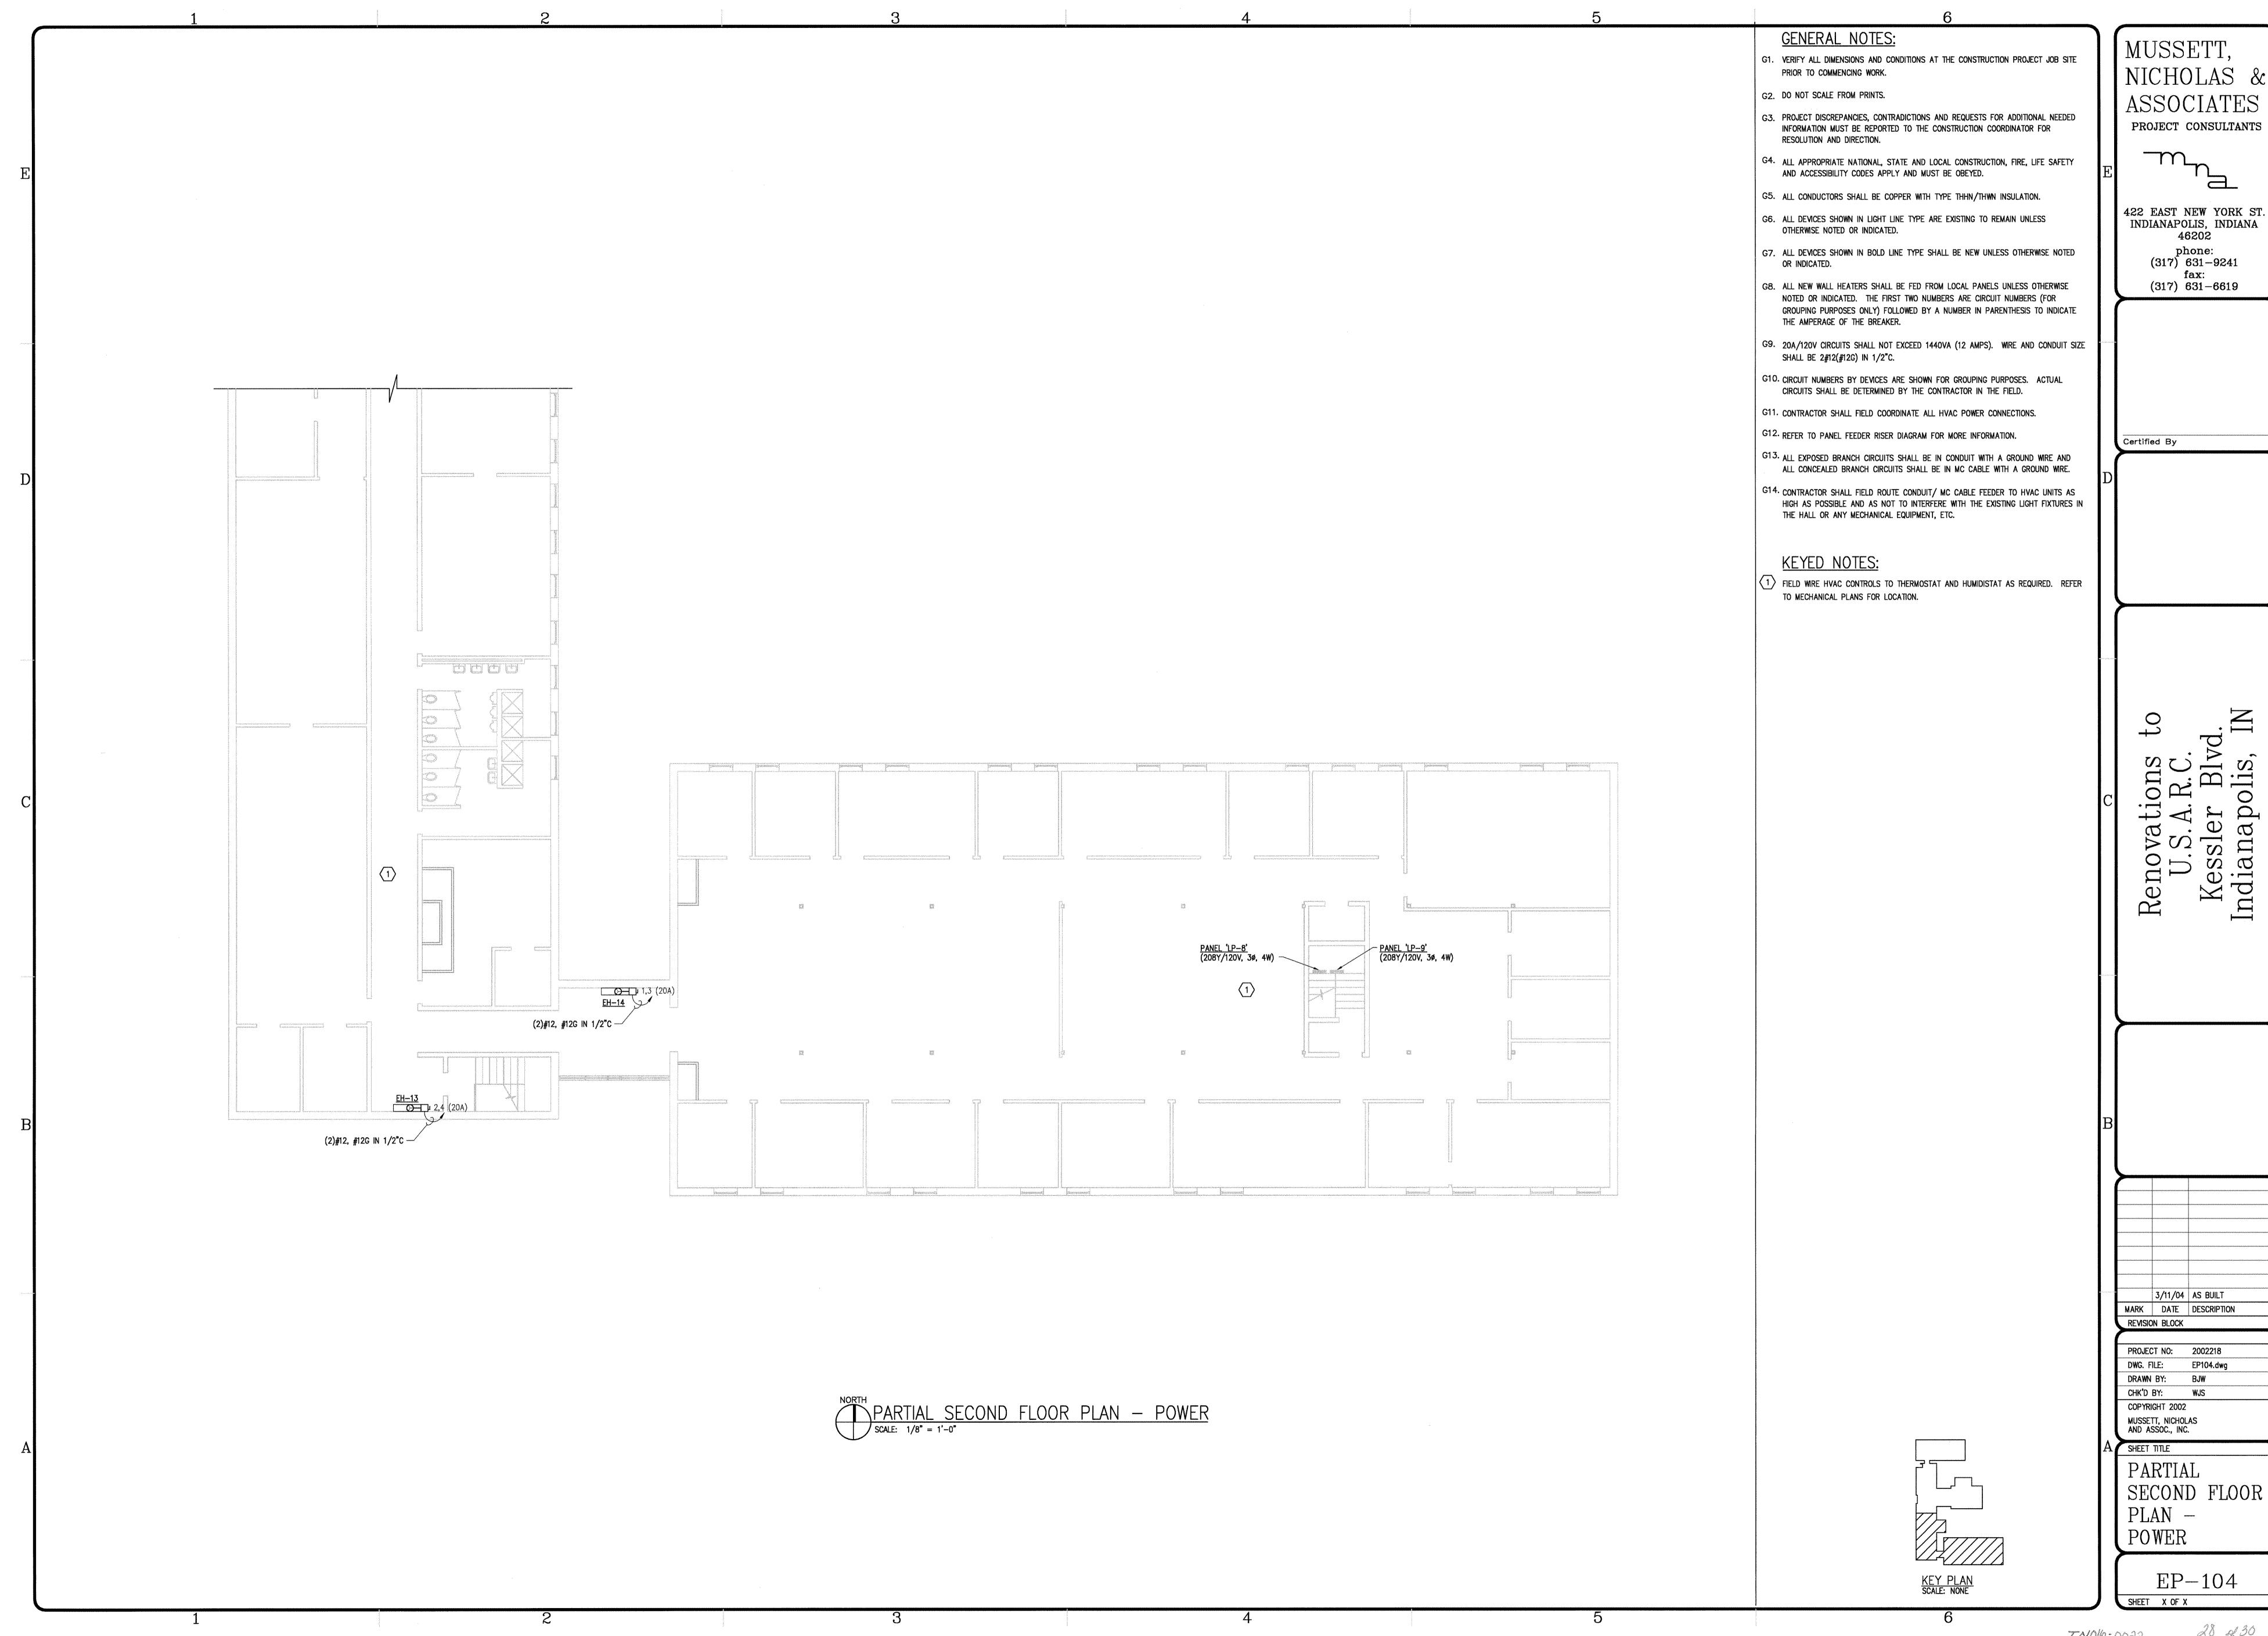

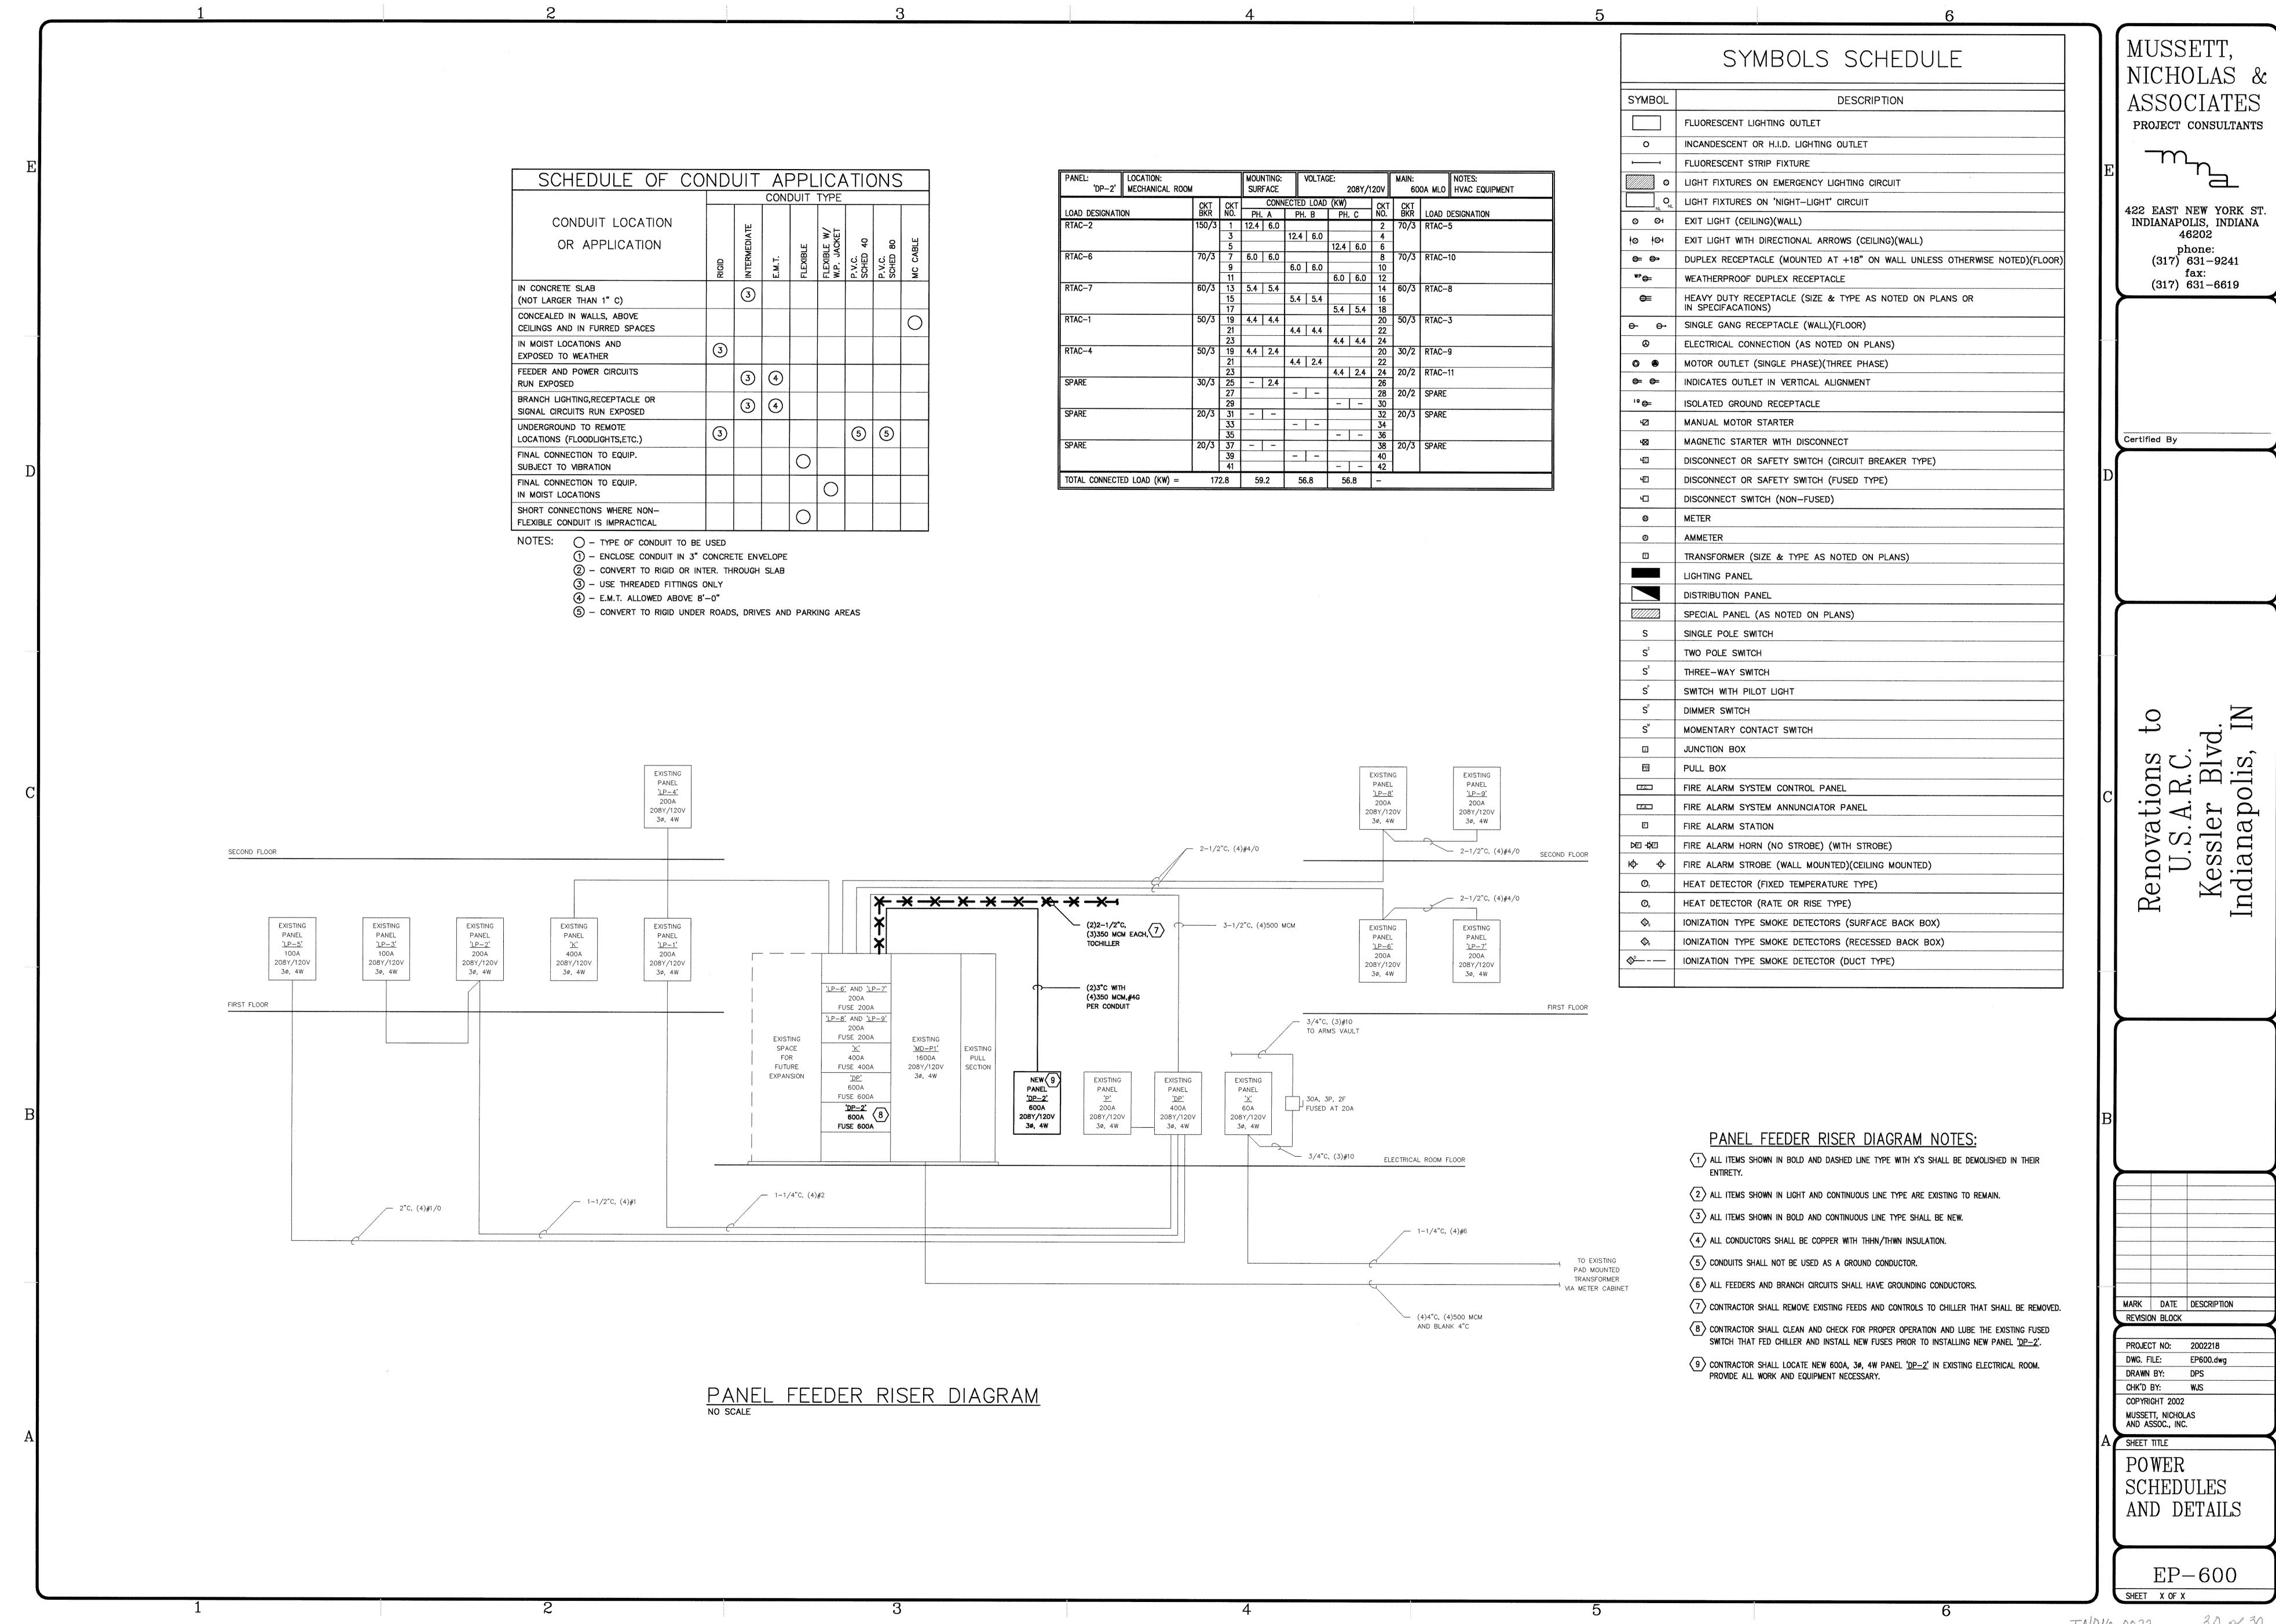

IND14-0022

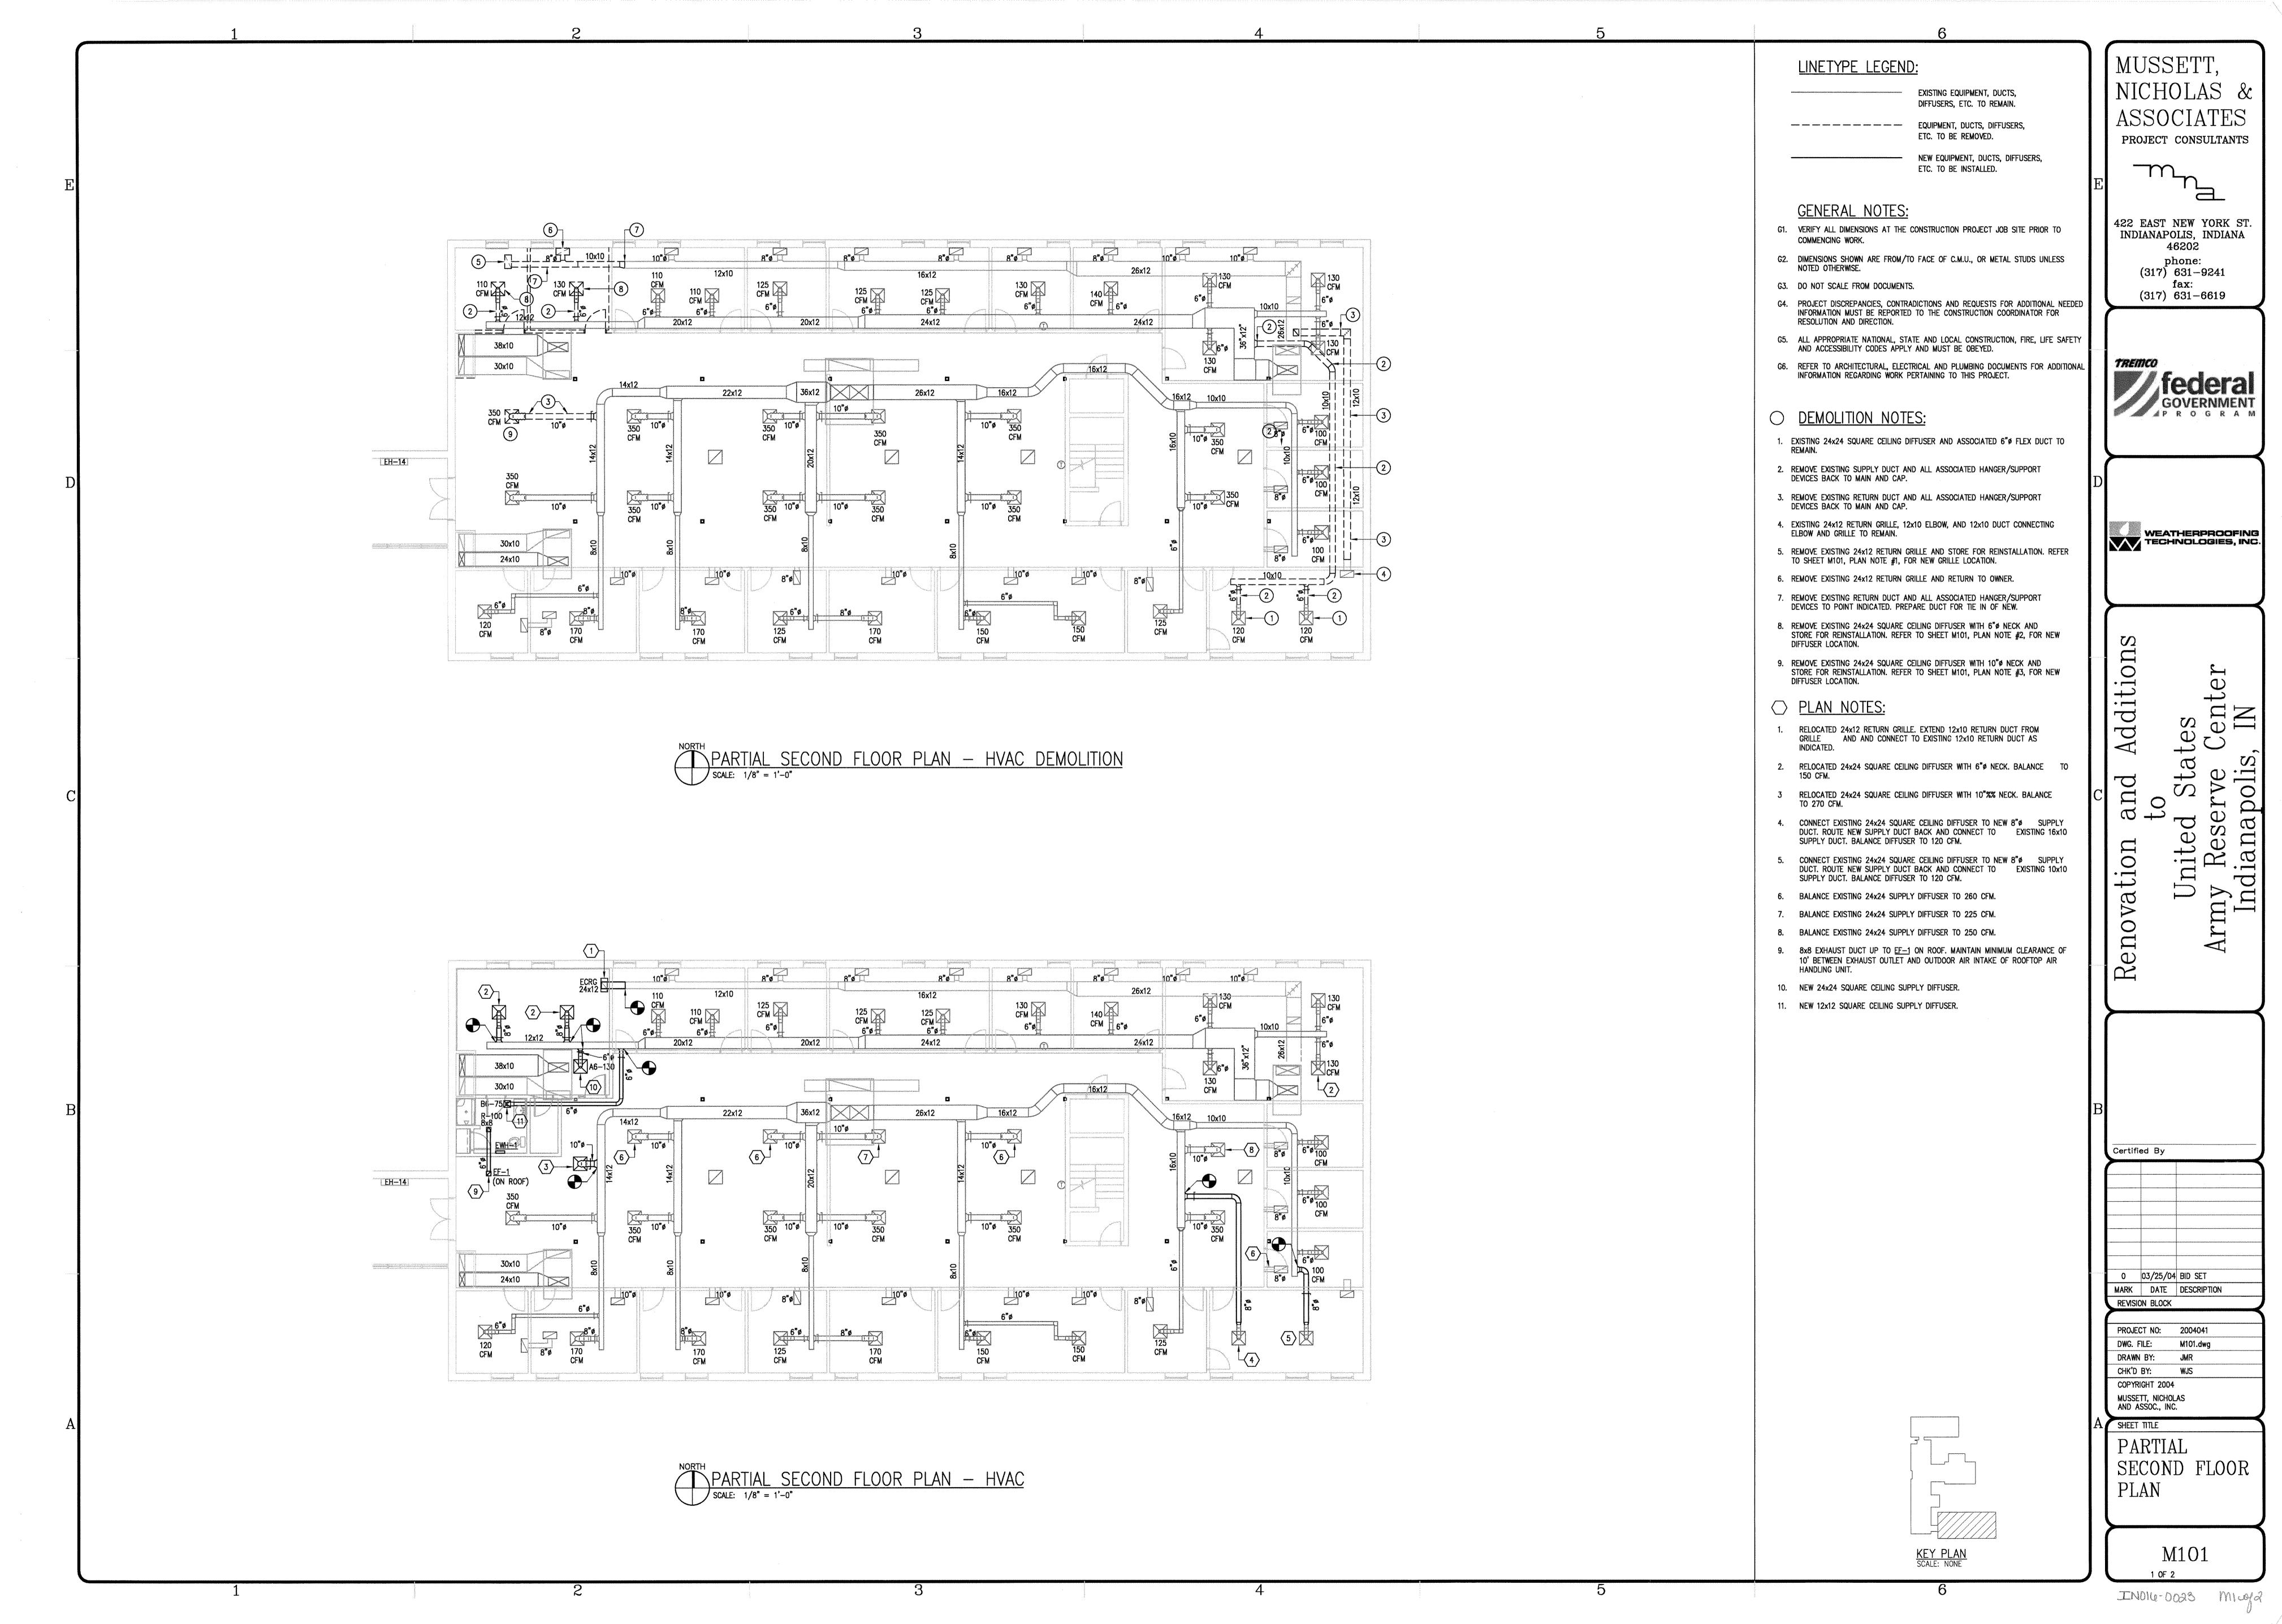

FLOOR DRAIN AND CLEANOUT SCHEDULE				
	FLOOR DRAINS		CLEANOUTS	
	FD-A		CO-A	
BASE OF DESIGN	JOSAM 30000-A	BASE OF DESIGN	JOSAM 58900	
BODY MATERIAL	CAST IRON	BODY MATERIAL	CAST IRON	
STRAINER MATERIAL	CAST IRON	OUTLET CONN.	NO HUB	
top finish	NICKEL BRONZE	CLOSURE	BRONZE	
TRAP	DEEP SEAL	COVER MATERIAL		
LOADING CLASS	LIGHT DUTY	COVER FINISH		
TOP SHAPE	ROUND	COVER SHAPE		
REMARKS		LOADING CLASS.	***	
VEWVIVO		REMARKS	-	

PLUMBING EQL	IPMENT SCHEDULE
TAG	DESCRIPTION
DWH—1	ELECTRIC DOMESTIC WATER HEATER  "LOCHINVAR" MODEL JRJ031K  208 VOLTS, SINGLE PHASE  NOMINAL REQUIRED CAPACITY: 30 GALLONS  TANK DIMENSIONS: 22" DIA. x 29-3/4" TALL
TMV1	DOMESTIC HOT WATER THERMOSTATIC MIXING VALVE  "LAWLER" MODEL #67-10  5 PSI PRESSURE DROP © 2.5 GPM FLOW  MINIMUM FLOW: 1/2 GPM  OUTLET TEMPERATURE SETPOINT: 110" (ADJUSTABLE)

	P	LUMBING FI	XTURE	SCHE	DULE	
		PIPE CONNECTION				
MARK	DESCRIPTION	HW	CW	W	V	MOUNTING HEIGHT
WC1	WATER CLOSET	<u></u>	1"	4"	2"	SEAT AT 15"
L-2	LAVATORY	1/2"	1/2"	1 1/2"	1 1/2"	RIM AT 32"
SH-2	SHOWER	3/4"	3/4"	2"	1 1/2"	CONTROL VALVE AT 43" HEAD AT 65"

PIPING INSULATION SCHEDULE (INDOOR)

FLUID TEMP. RANGE (T)

VAPOR BARRIER REQ'D

RUNOUTS (\*NOTE 1 & 2)

INDIVIDUAL PLUMBING UNITS.

FE FLEXIBLE ELASTOMERIC

MF MINERAL FIBER (FIBERGLASS)

ABBREVIATIONS
INSULATION TYPES

INSULATION TYPE

JACKET TYPE

1" & LESS 1.25" TO 2" 2.5" TO 4"

5" & ABOVE

DOMESTIC HOT

WATER & RETURN

100-130

MF OR FE

0.5

NOTES: 1. RUNOUTS NOT EXCEEDING 12 FEET IN LENGTH AND 2" PIPE TO INDIVIDUAL HVAC TERMINAL UNITS.
2. RUNOUTS THAT ARE NOT LARGER THAN 1" AND NON—CIRCULATING TO

COLD WATER


40-75

MF OR FE

YES

----

0.5

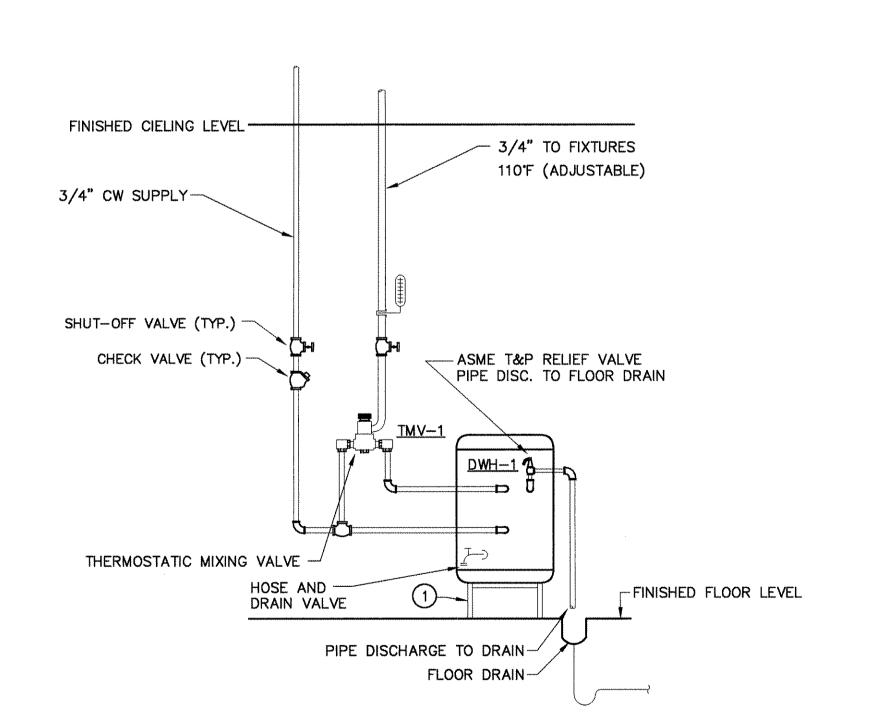

1	PLUMBING	CONT	RACTOR	ТО	PROVIDE	STAND	ТО	HOLD	ELECTR	IC
	WATER HE	EATER.	воттом	OF	WATER	HEATER	AT	MINIMU	JM 18"	A.F.F.



MARK NO.	A6	B6	R	
MANUFACTURER	TITUS	TITUS	TITUS	
MODEL NO.	TMS	TMS	350FL	
DESCRIPTION	SQUARE	SQUARE	EXHAUST	
	DIFFUSER	DIFFUSER	GRILLE	
	SPEC. SECTION 15855	SPEC. SECTION 15855	SPEC. SECTION 15	
MAXIMUM CFM	<b>18</b> 5	170	<del>-</del>	
APD (IN. W.C.)	0.09	0.09	0.05	
AT MAXIMUM CFM	0.03	0.03	0.03	
MAX — NC LEVEL	20	20	20	
AT MAXIMUM CFM			2.0	
NECK SIZE	6 <b>"</b> ø	6 <b>"</b> ø	****	
FACE SIZE	24x24	12x12		
MODULE SIZE	24×24	12x12	SEE PLANS	
CONST. MATERIAL	AL	AL	AL	
FINISH	WE	WE	WE	
ACCESSORIES	*-	-	****	
REMARKS			3/4" BLADE SPACI 35" DEFLECTION	
LEGEND: /NECK				

	FAN AND POWER VENTILA	TOR SCHEDULE
	MARK NO.	EF-1
******	NAME/SERVICE	RESTROOM
		EXHAUST
	LOCATION	ROOF
		RESTROOM 101
	MANUFACTURER	GREENHECK
	MODEL	G-060-D
	TYPE	CENTRIFUGAL
	:	DIRECT DRIVE
	SPECIFICATION SECTION	15838
Œ	ELEVATION (FEET ABOVE SEA LEVEL)	
PERFORMANCE	AIRFLOW RATE (CFM)	100
₹ P	TOTAL STATIC PRESSURE	.30
出	MAXIMUM BRAKE HORSEPOWER	-
	TYPE	ODP
MOTOR	SPEED (RPM)	1550
MO.	HORSEPOWER	1/60
	VOLTZ/HERTZ/PHASE	115/60/1
IER	TYPE	*****
CONTROLLER		
8	SPECIFICATION SECTION	

\* FAN SHALL RUN CONTINUOUSLY \* PROVIDE ROOF CURB, BIRDSCREEN, AND BACKDRAFT DAMPER.

## \*PURCHASED BY MNA CONSTRUCTORS, THEN ASSIGNED TO HVAC CONTRACTOR FOR INSTALLATION.

MARK NO.	EWH1
	<del>-</del>
NAME	ELECTRIC WALL HEATER
MANUFACTURER	QMARK
MODEL	CWH3408
LOCATION	RESTROOM 101
SERVICE	HEATING
VOLTS @ 60 Hz	208
PHASE	1
WATTS	2000
AMPS	9.6
SHIPPING WEIGHT	
BTUH	+-
OPTIONS	UNIT MOUNTED THERMOSTAT

\*PURCHASED BY MNA CONSTRUCTORS, THEN ASSIGNED TO HVAC CONTRACTOR FOR INSTALLATION.

ASSIGNED TO HVAC CONTRACTOR FOR INSTALLATION.				
	FAN AND POWER VENTILATOR SCHEDULE			
	MARK NO.	EF-1		
	NAME/SERVICE	RESTROOM		
		EXHAUST		
,	LOCATION	ROOF		
ŀ		RESTROOM 101		
	MANUFACTURER	GREENHECK		
	MODEL	G-060-D		
	TYPE	CENTRIFUGAL		
	:	DIRECT DRIVE		
	SPECIFICATION SECTION	15838		
띨	ELEVATION (FEET ABOVE SEA LEVEL)	****		
PERFORMANCE	AIRFLOW RATE (CFM)	100		
2	TOTAL STATIC PRESSURE	.30		
足	MAXIMUM BRAKE HORSEPOWER	-		
	TYPE	ODP		
MOTOR	SPEED (RPM)	1550		
9	HORSEPOWER	1/60		
	VOLTZ/HERTZ/PHASE	115/60/1		
E	TYPE	****		
CONTROLLER				
8	SPECIFICATION SECTION			

\*ELECTRIC WALL HEATER TO BE SURFACE MOUNTED.


M501

IN016-0023 ma of a

PROJECT CONSULTANTS

422 EAST NEW YORK ST.

INDIANAPOLIS, INDIANA  $(317)^{\circ} 631 - 9241$ fax:

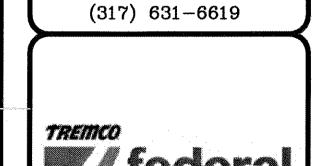





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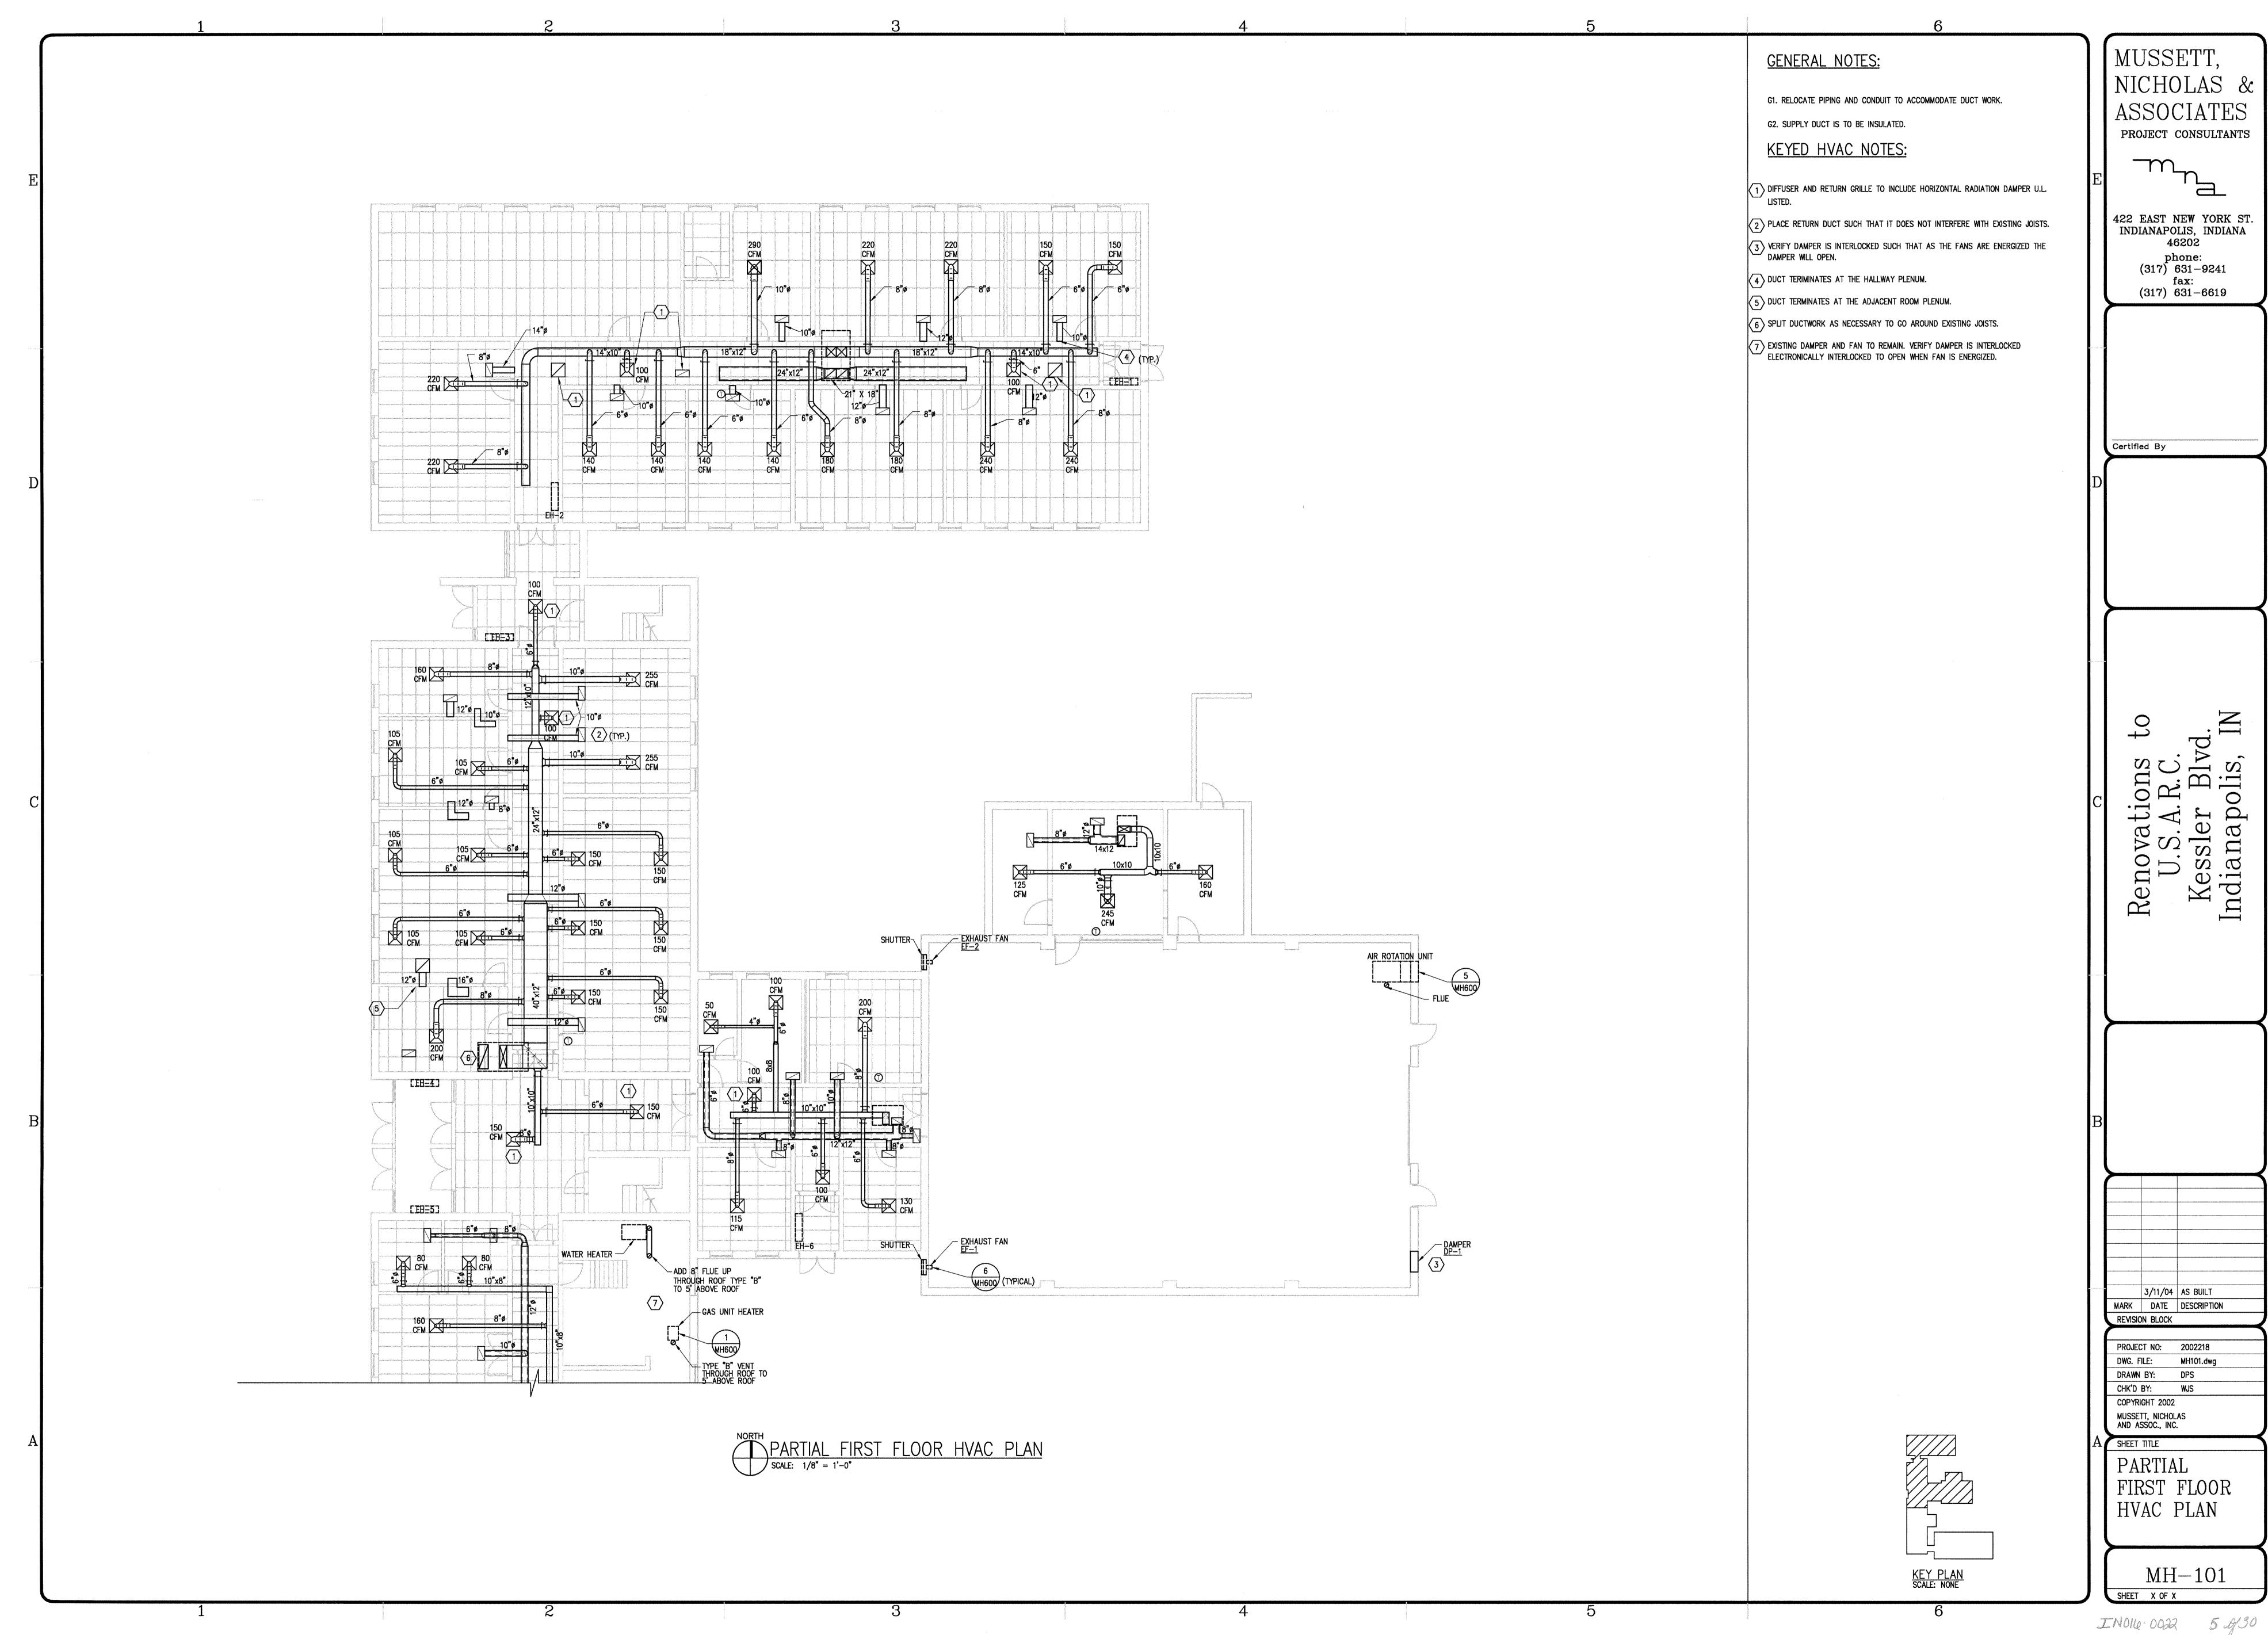
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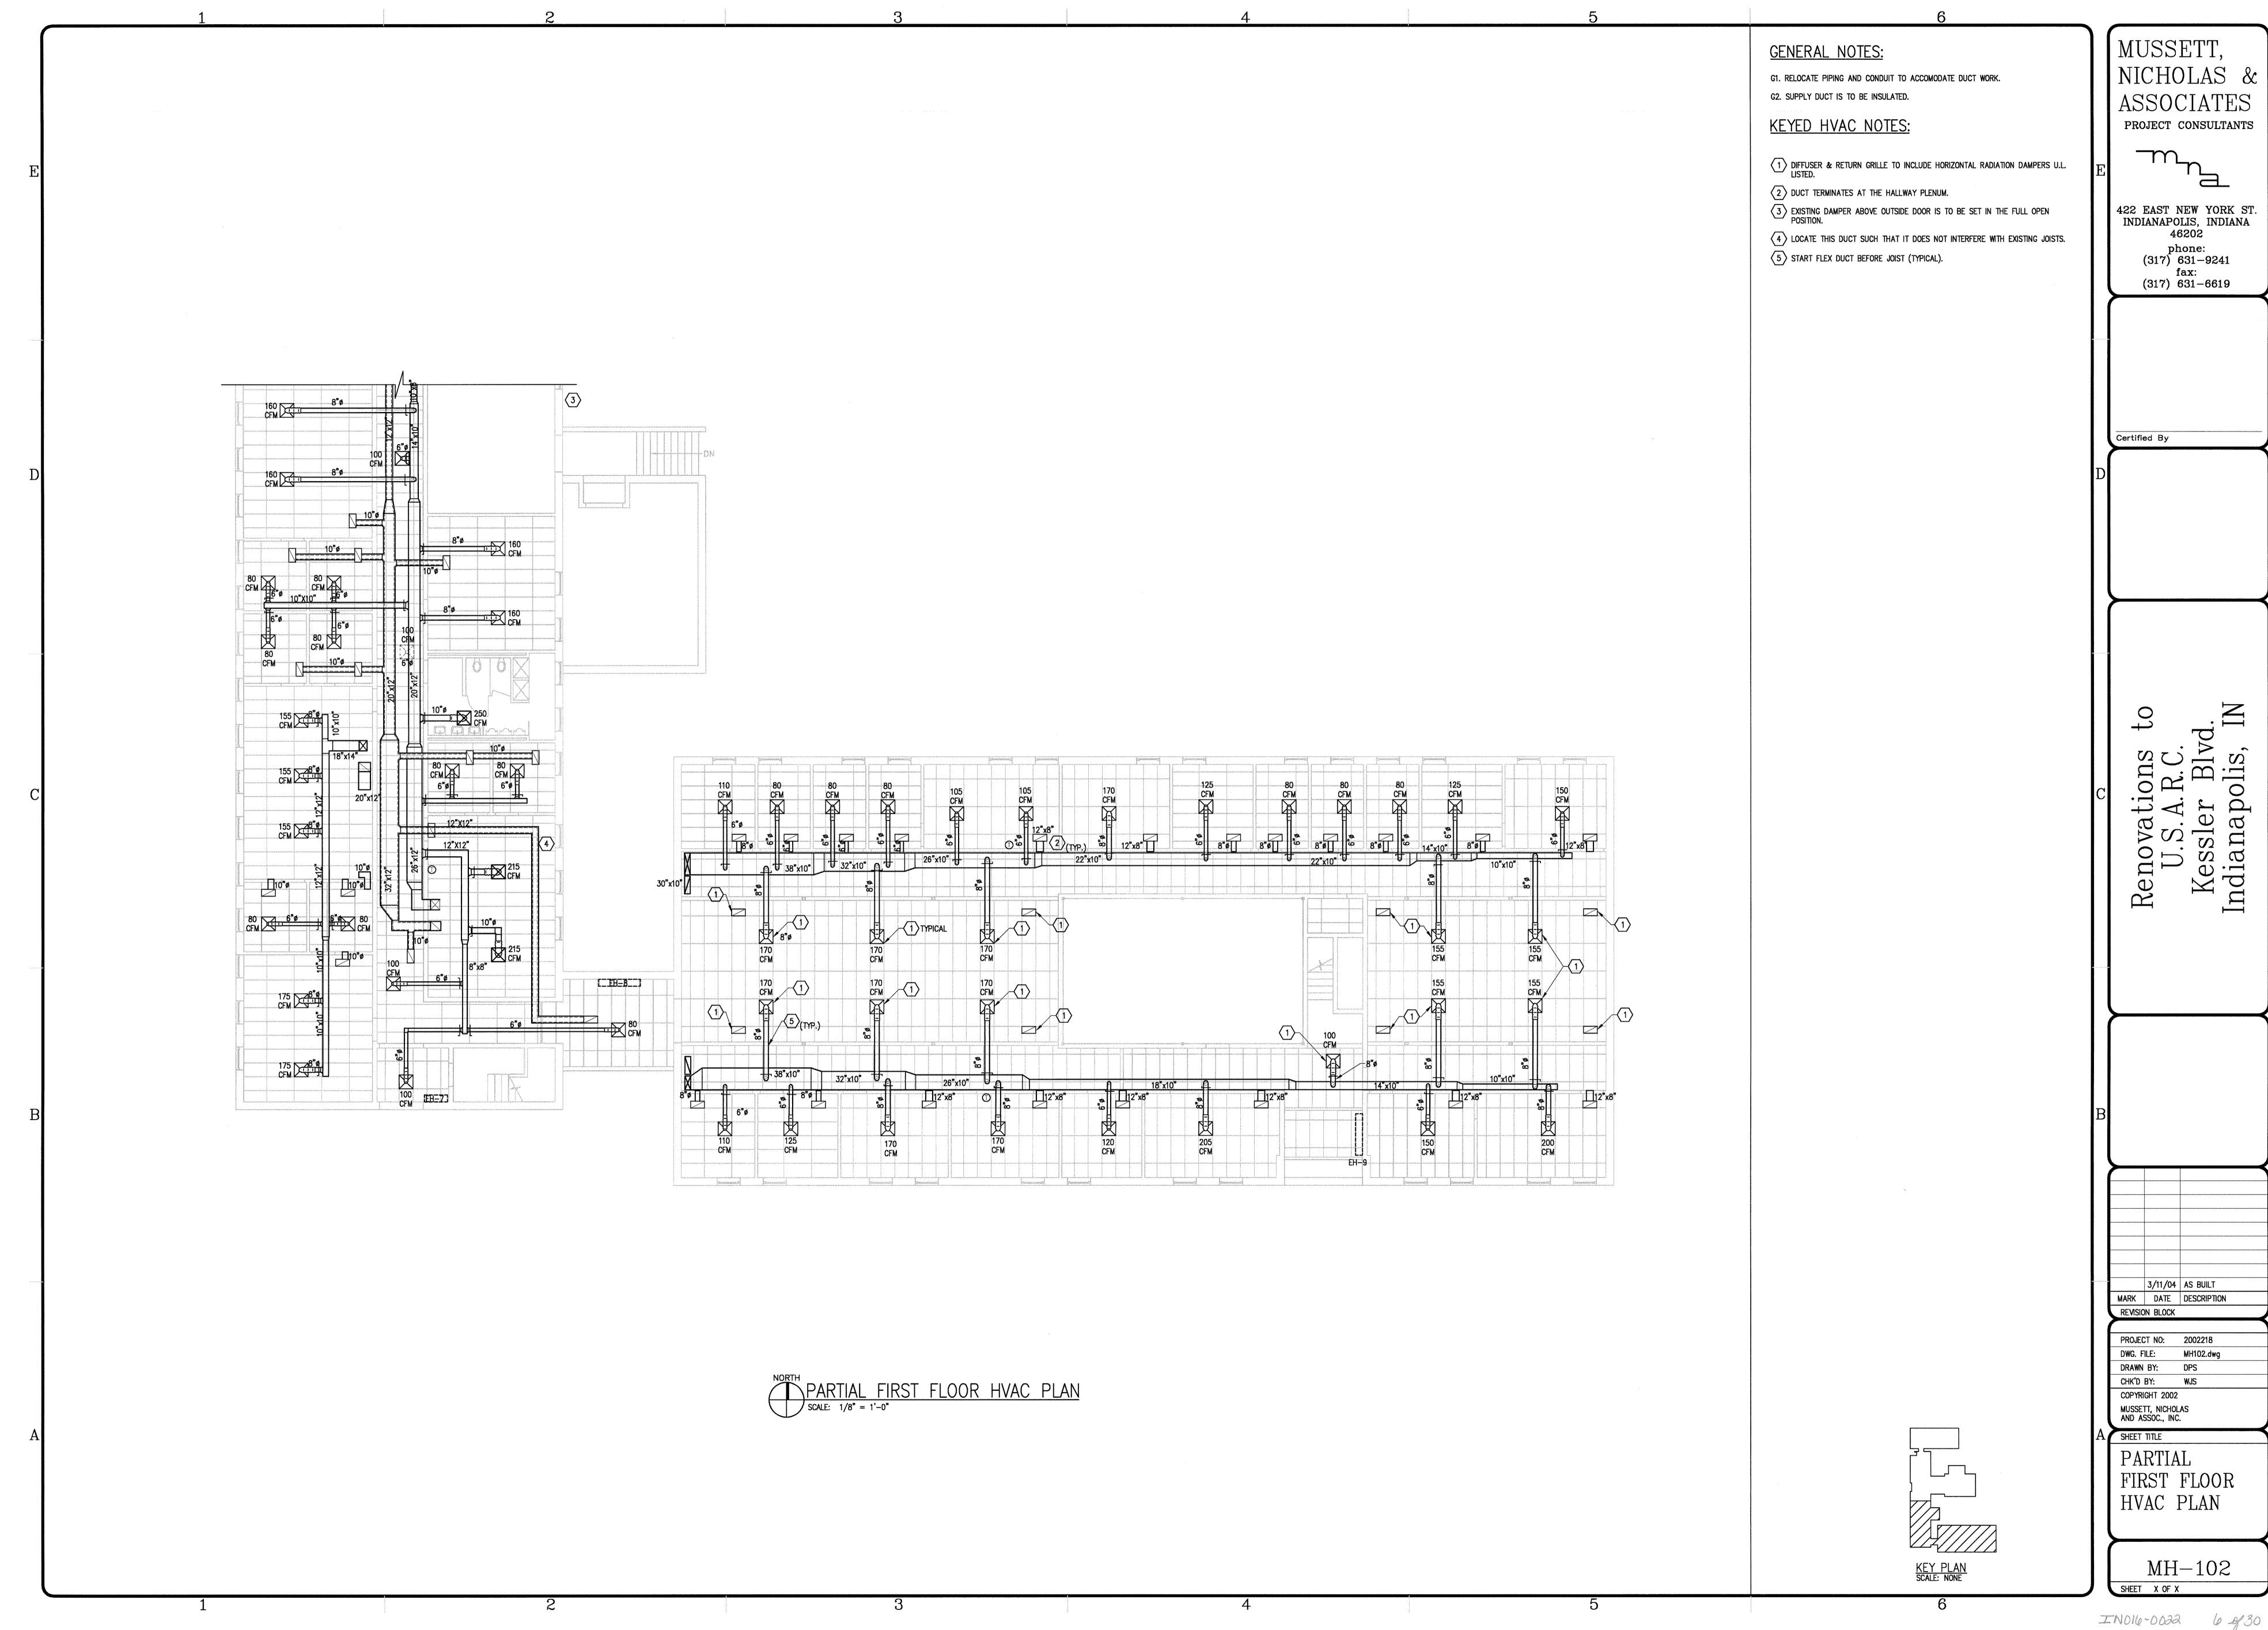
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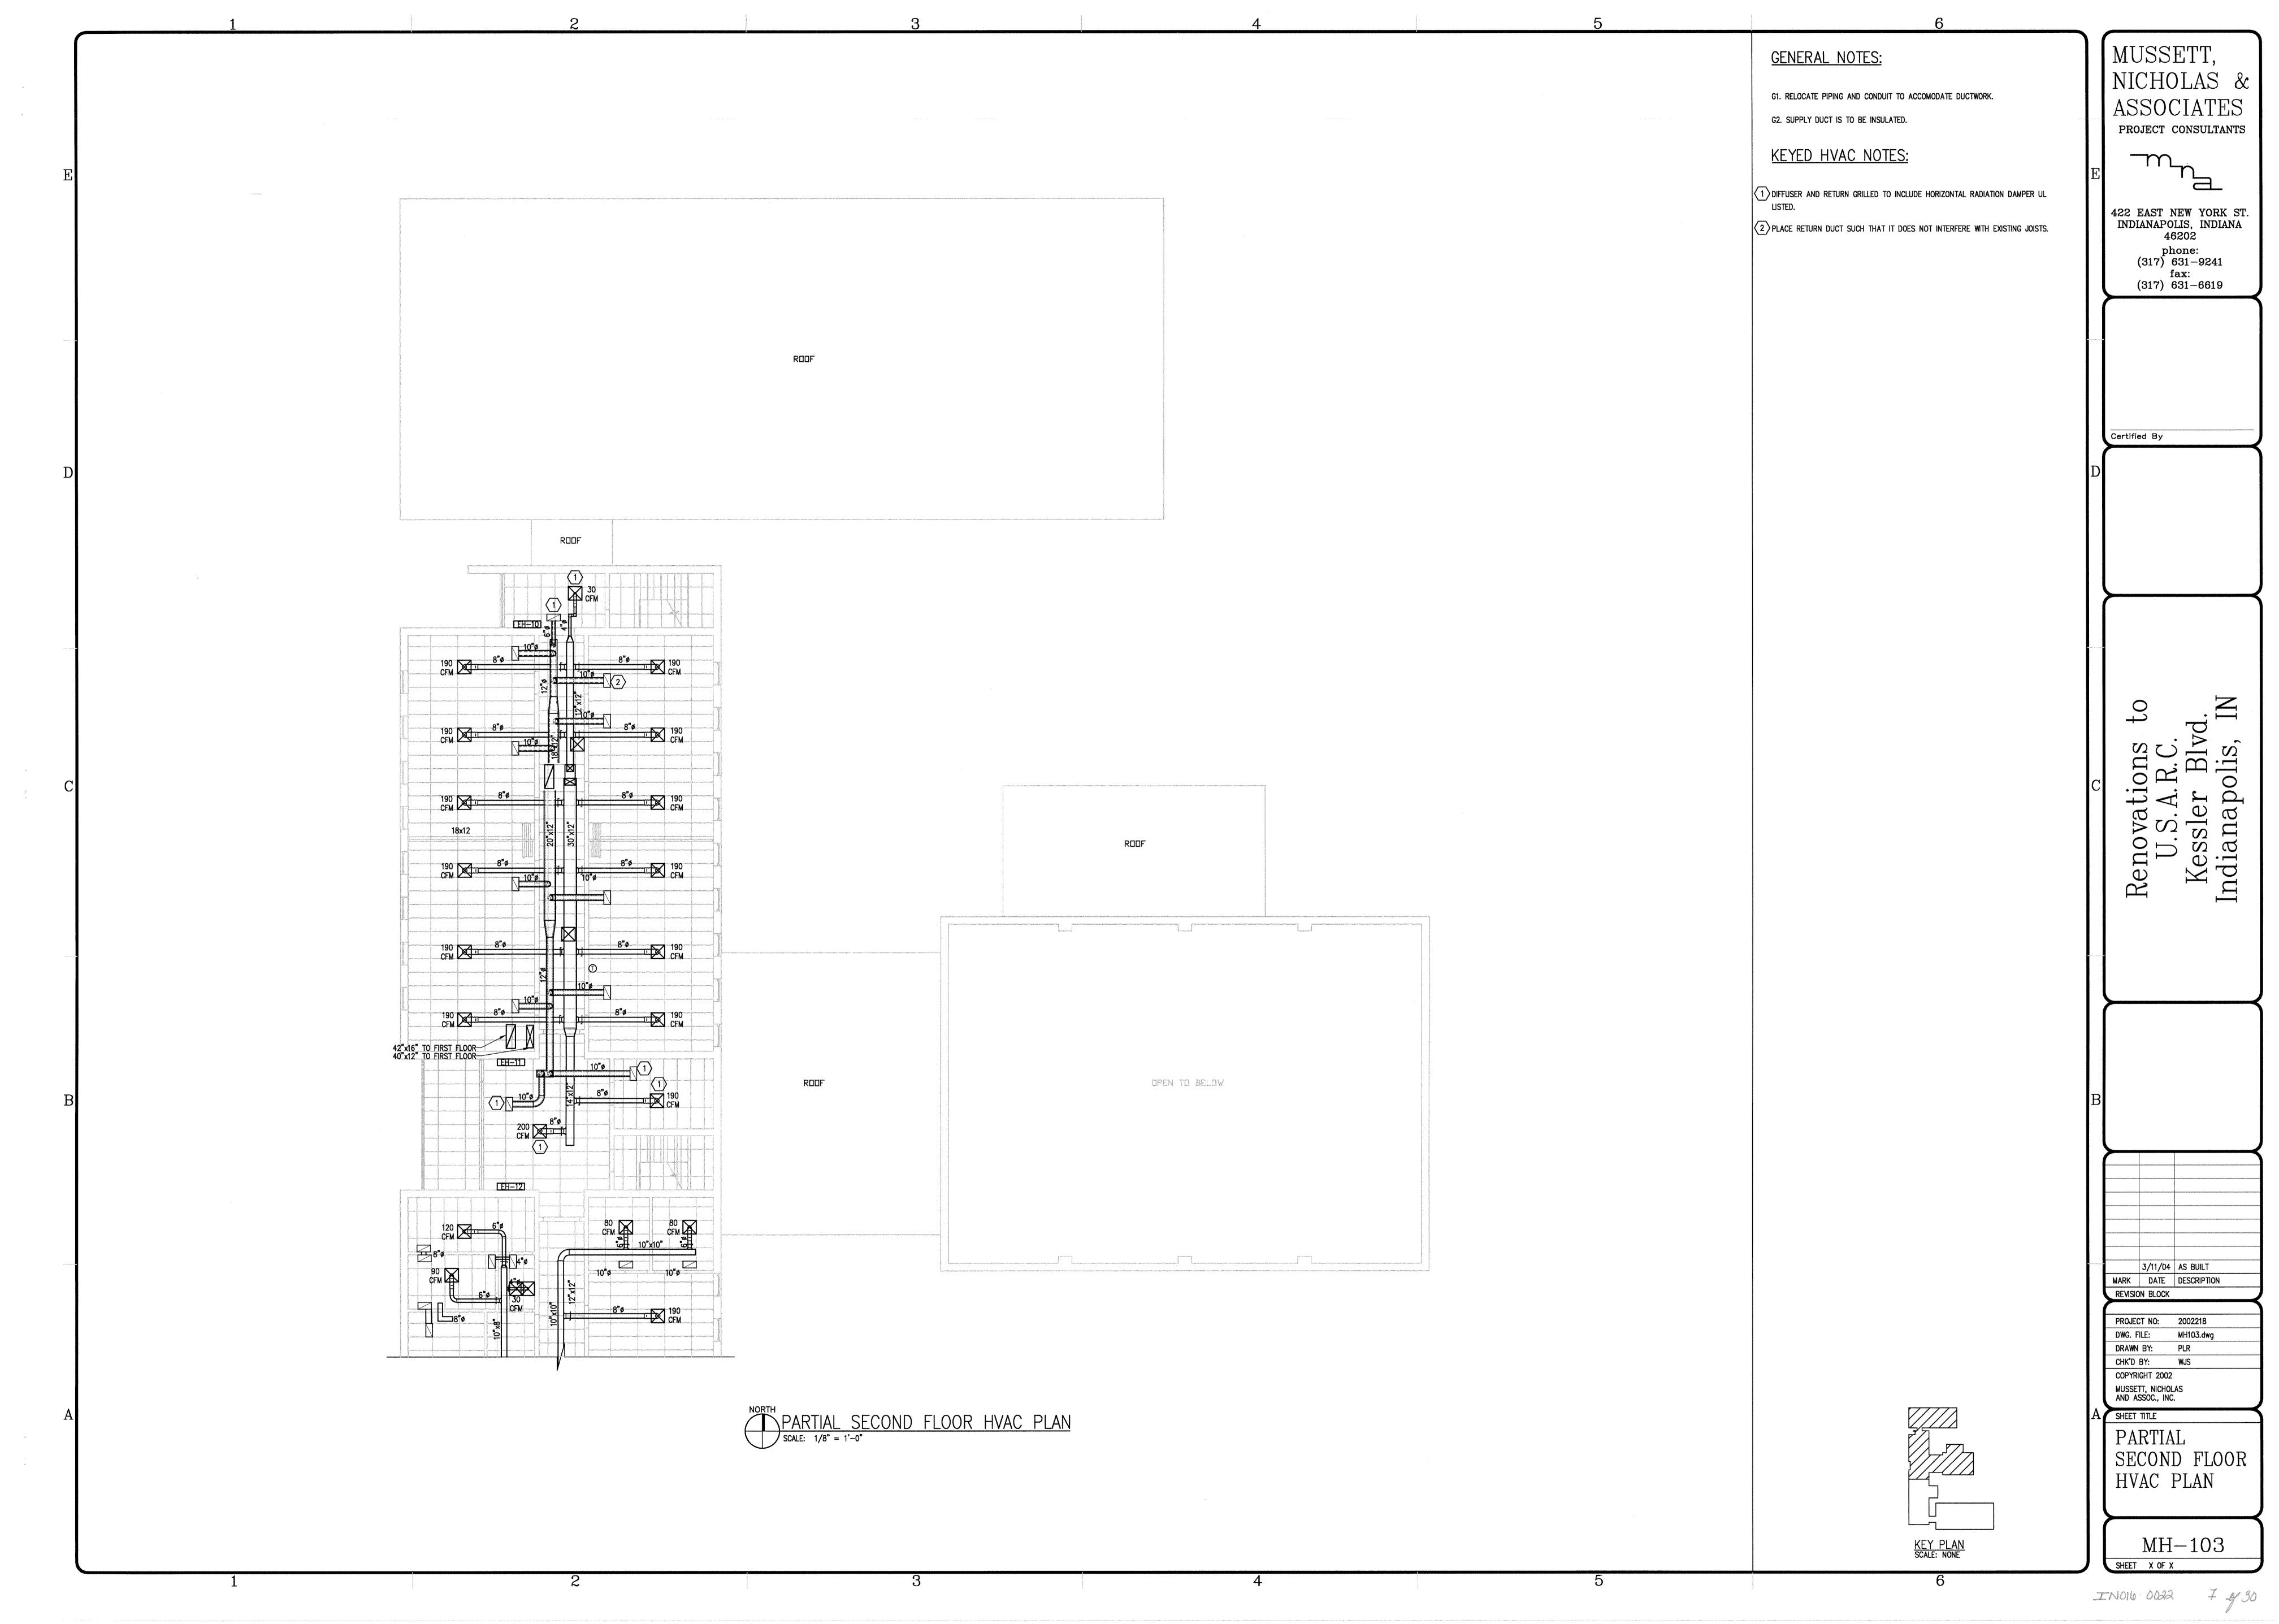
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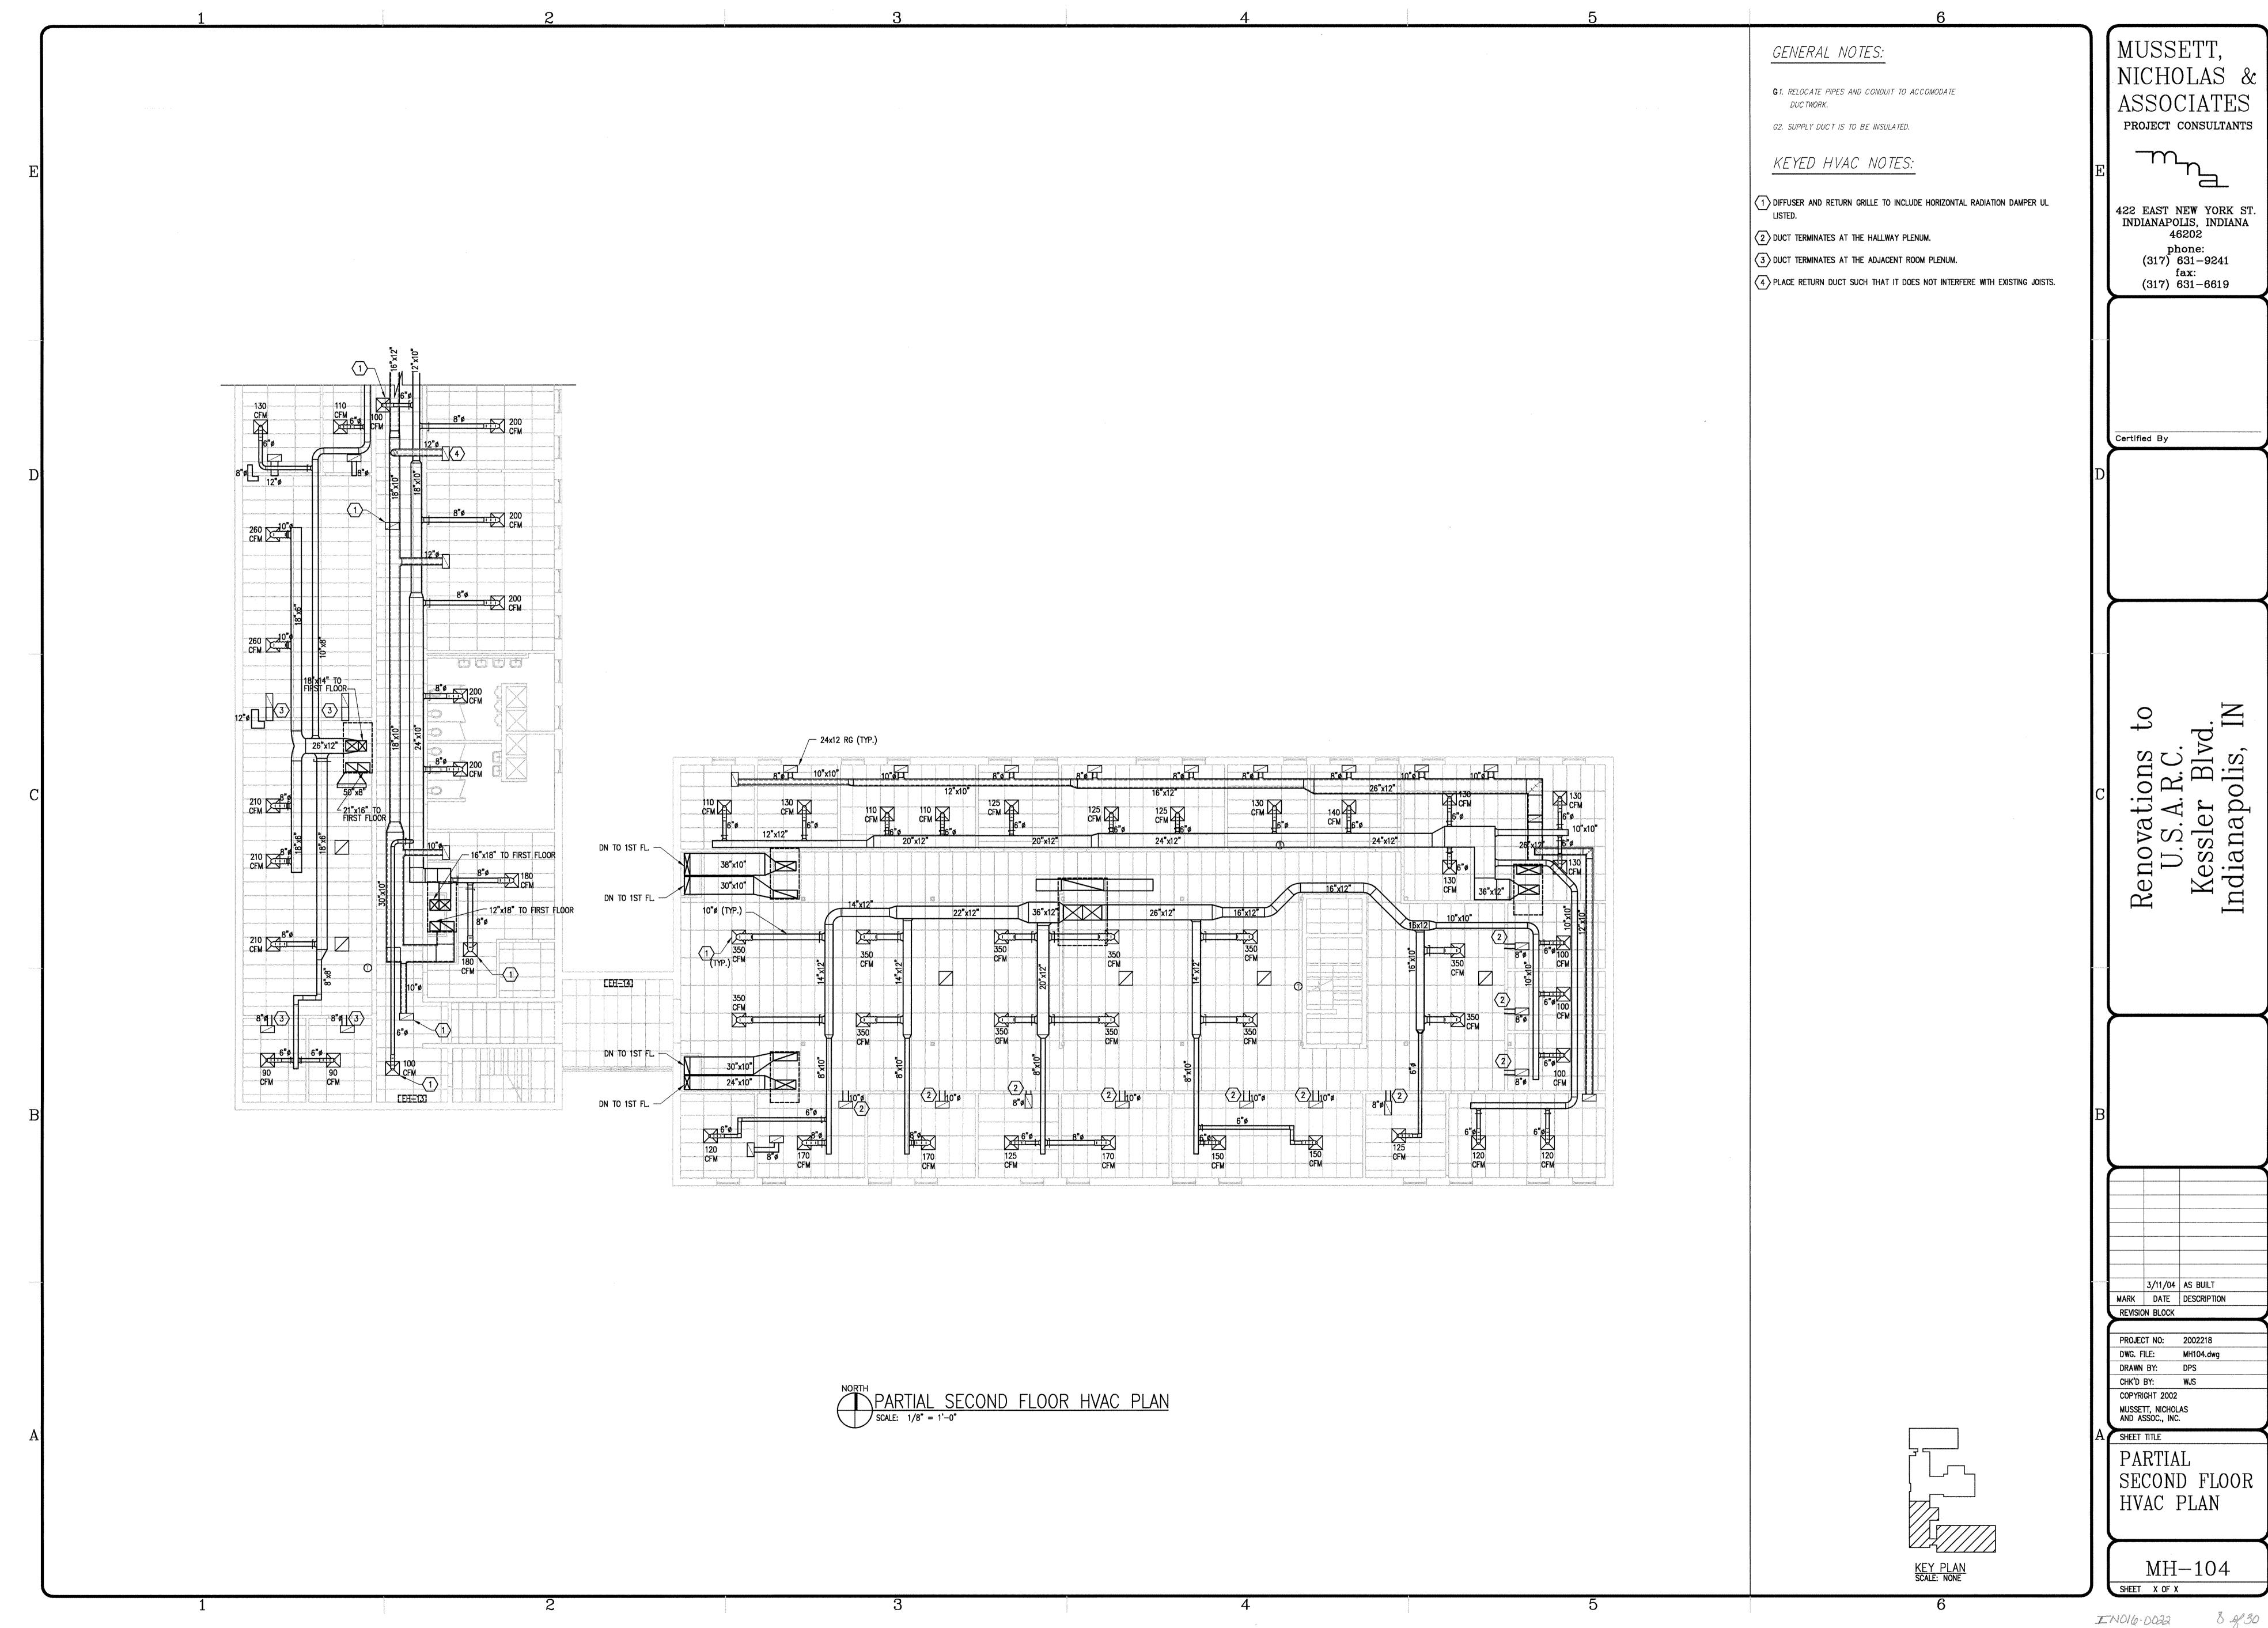
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COPYRIGHT 2004 MUSSETT, NICHOLAS AND ASSOC., INC. SHEET TITLE


MECHANICAL AND PLUMBING SCHEDULES













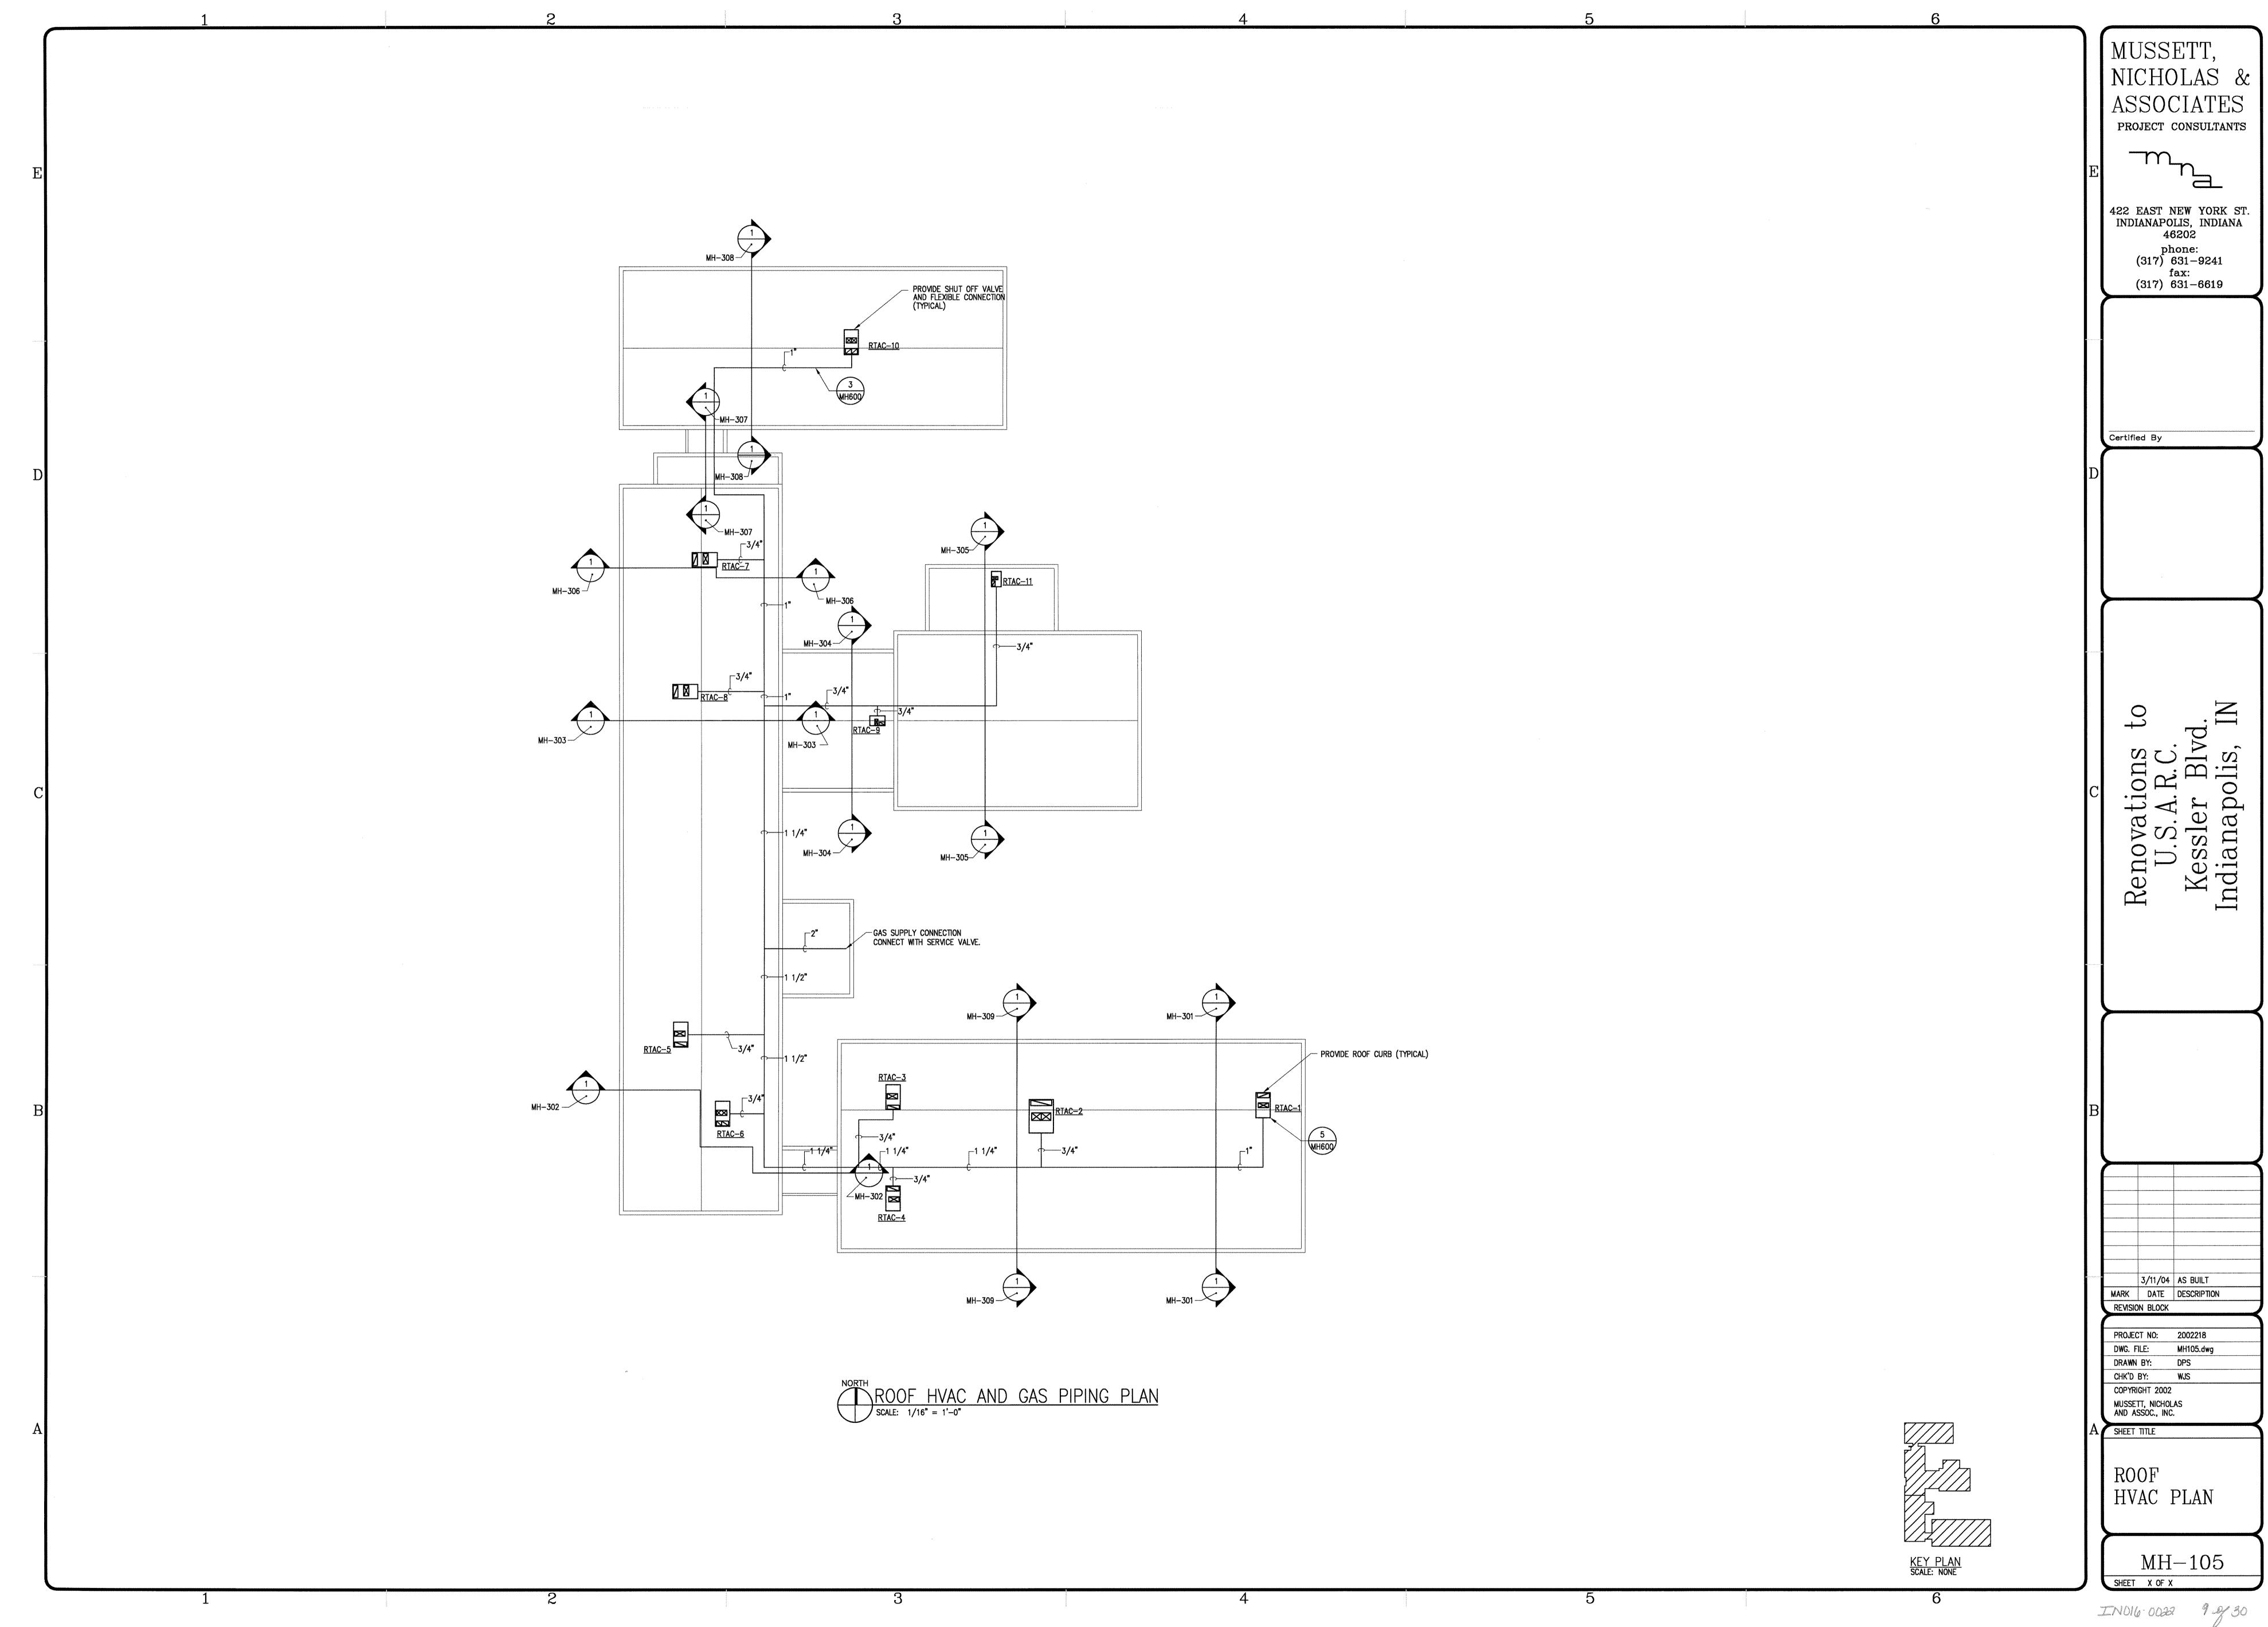


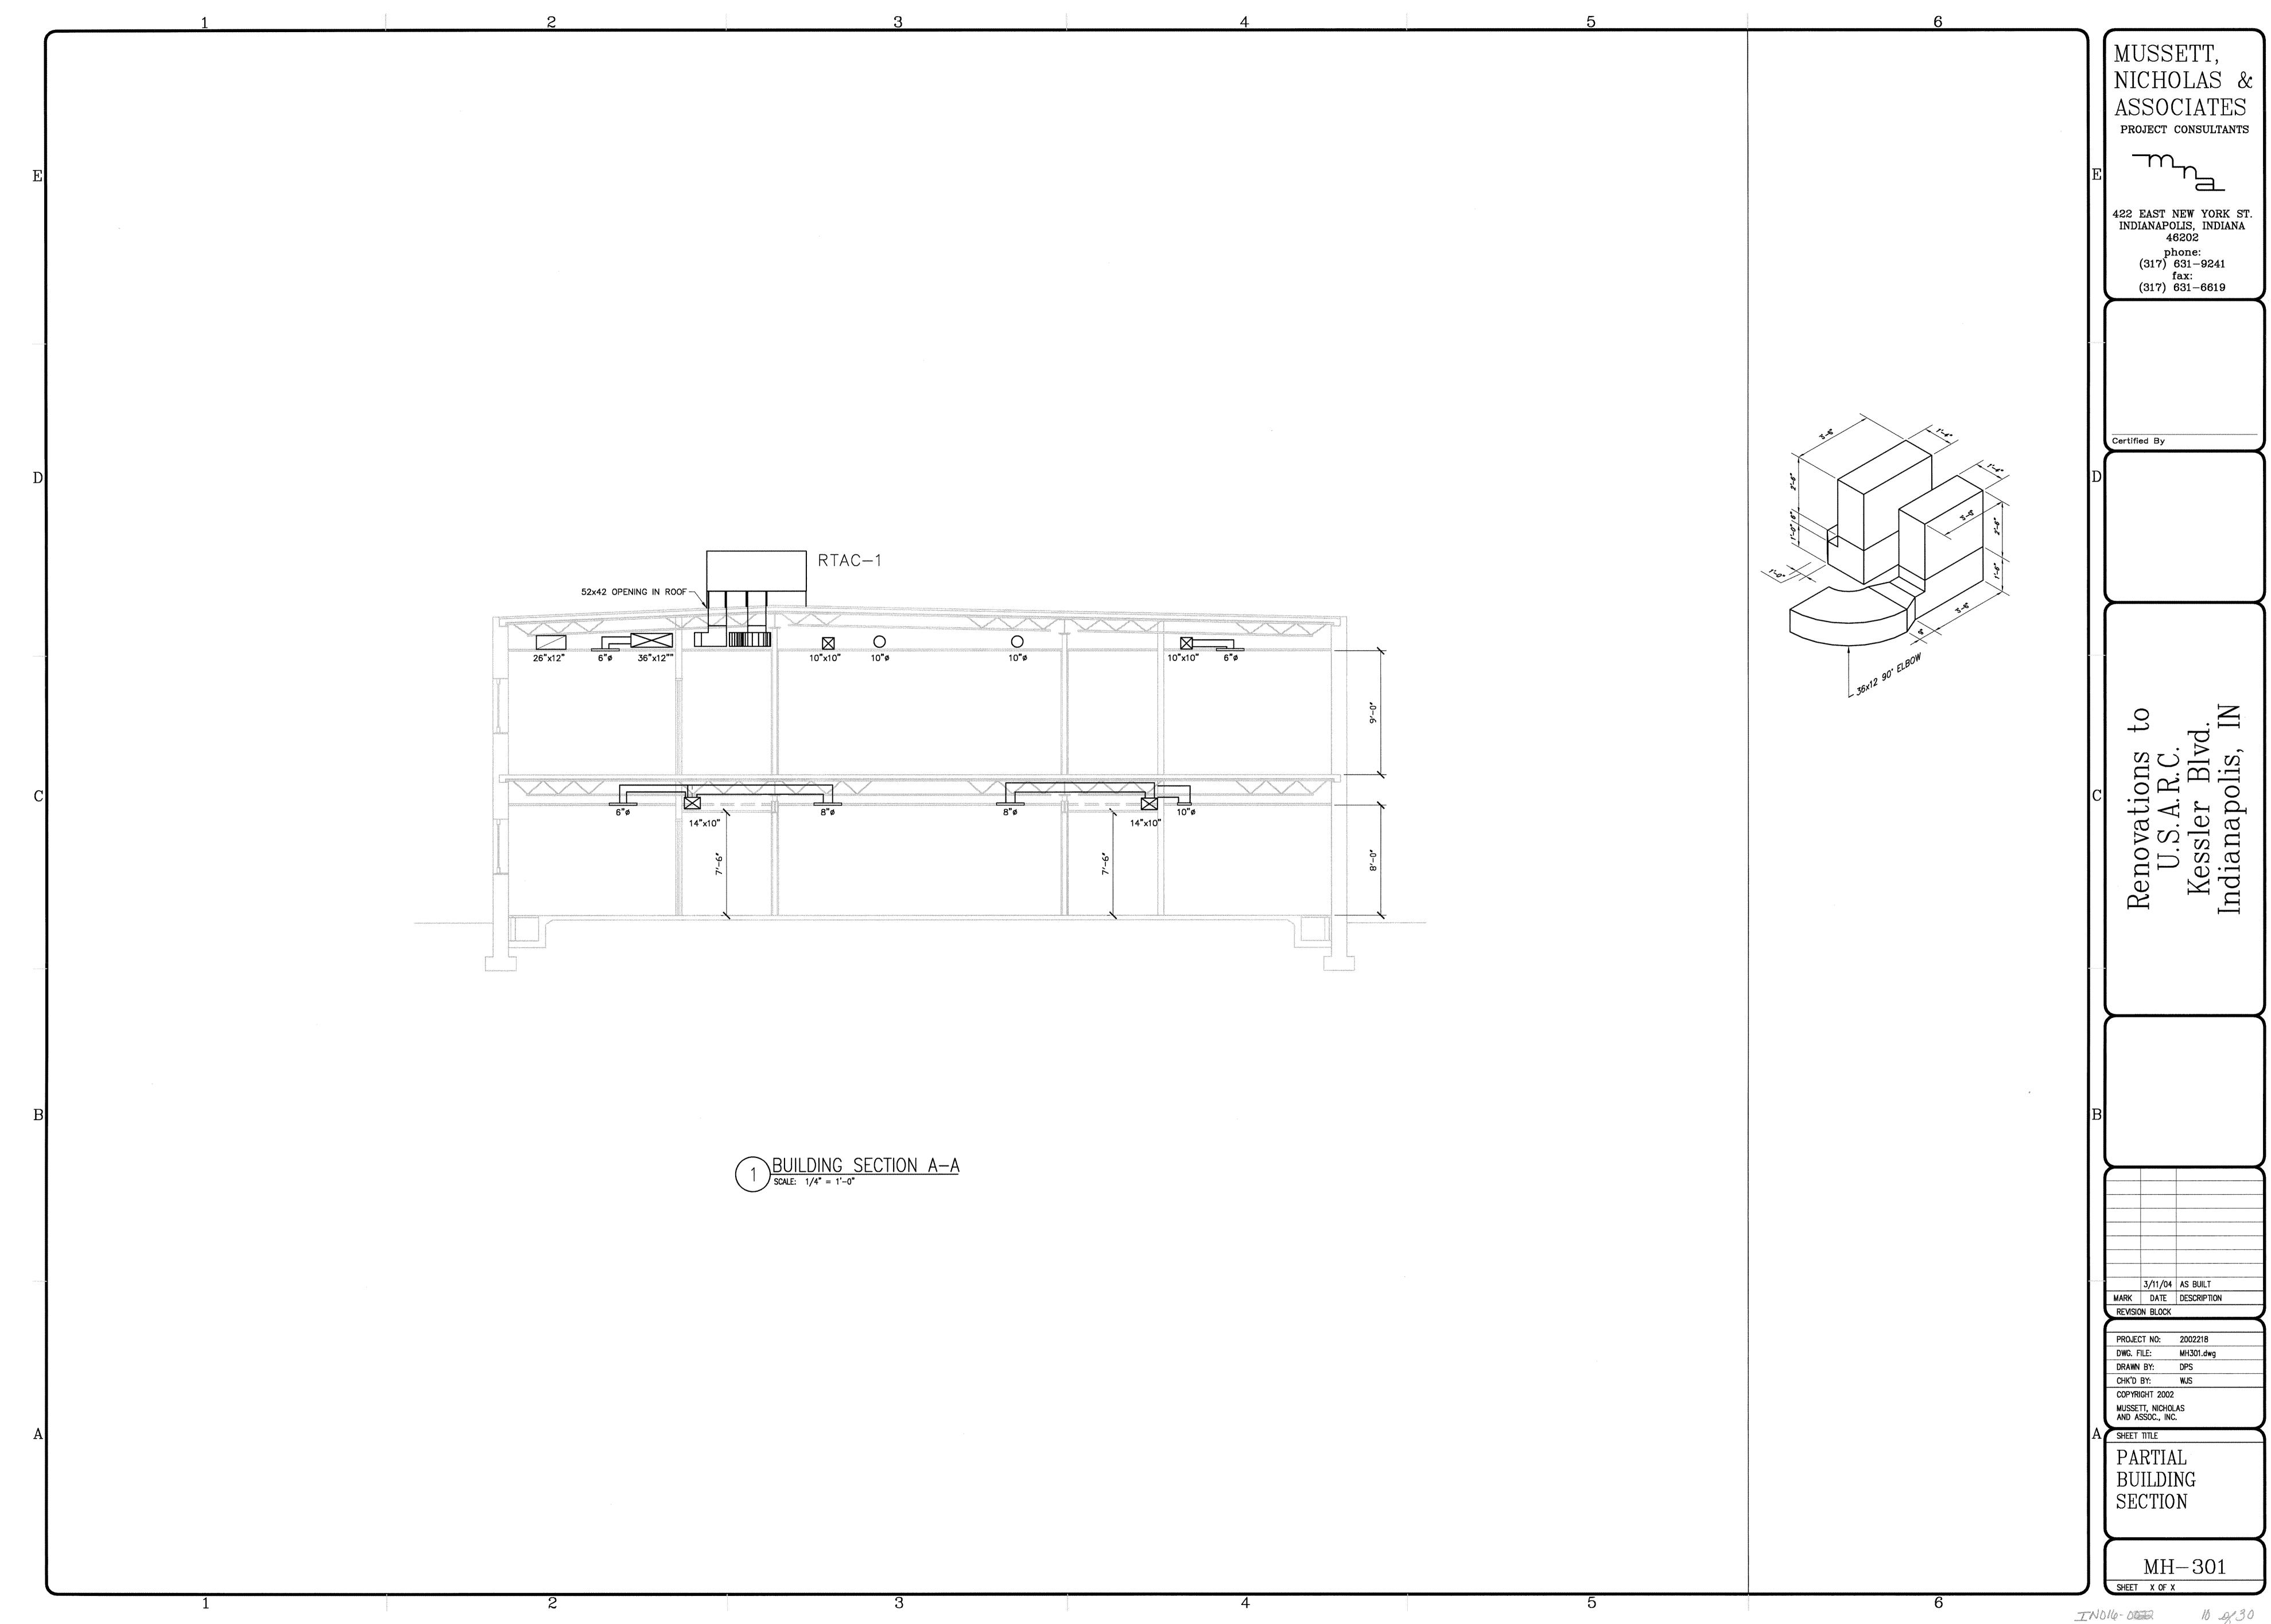


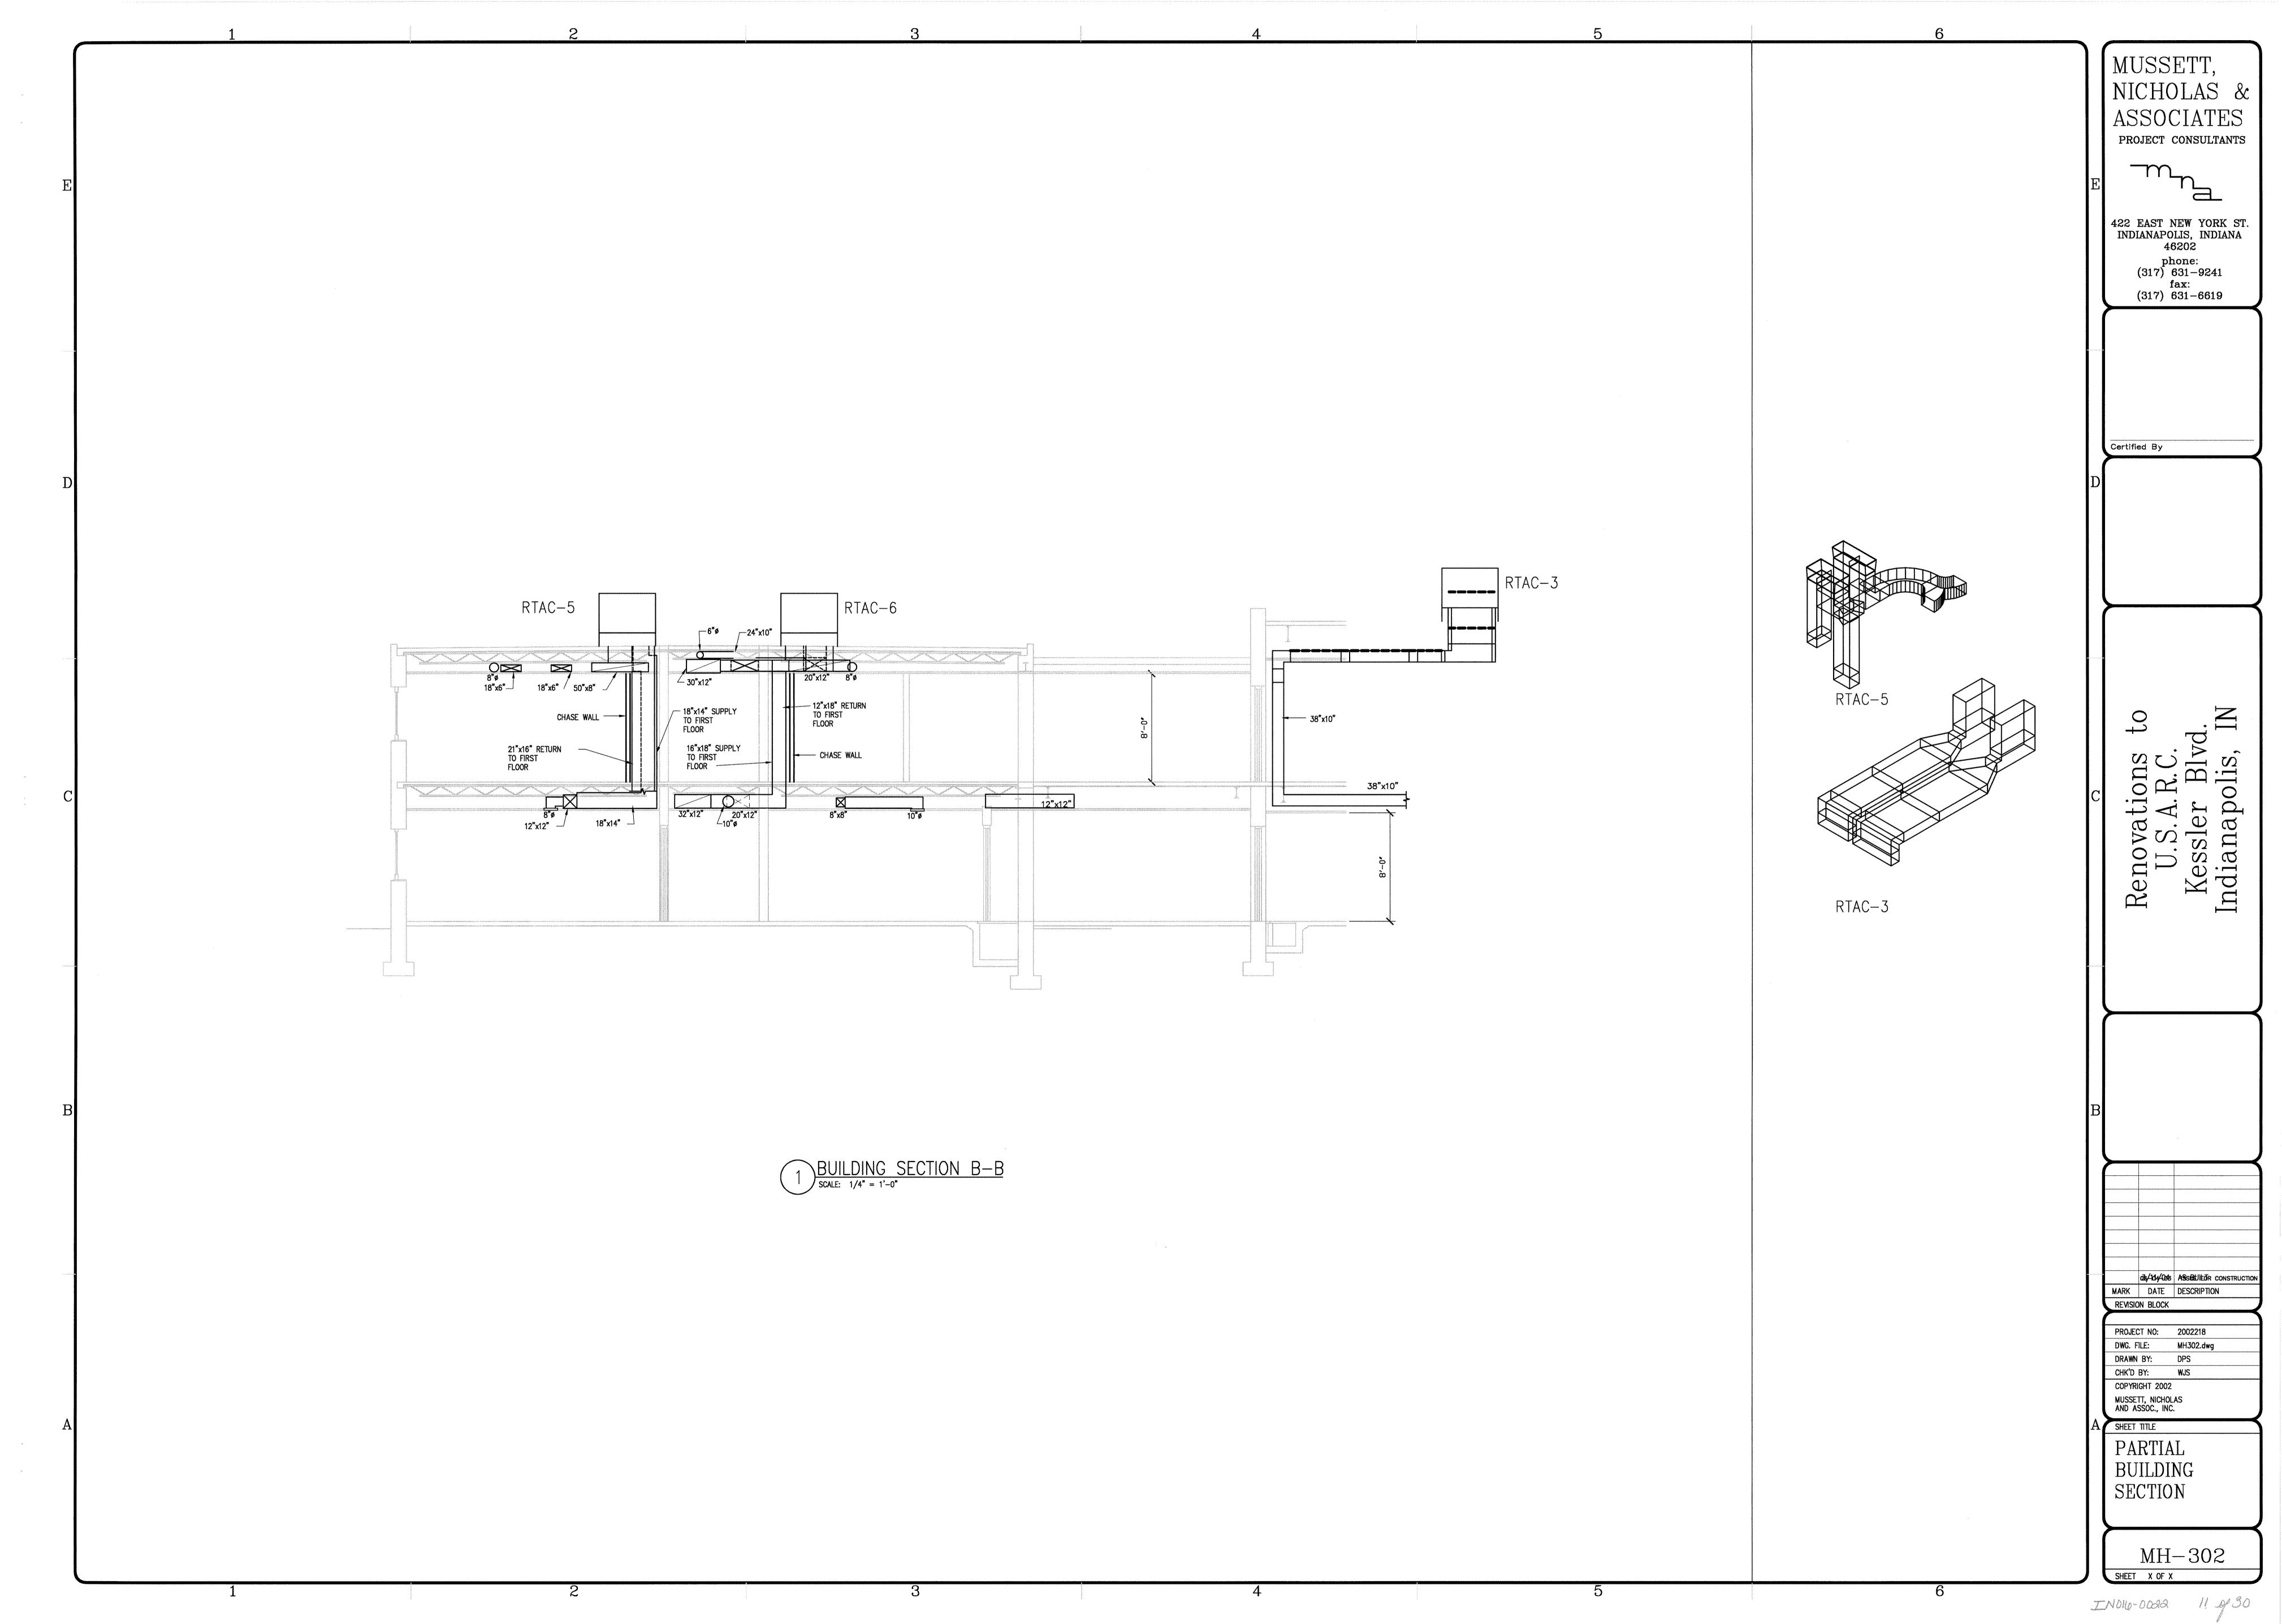


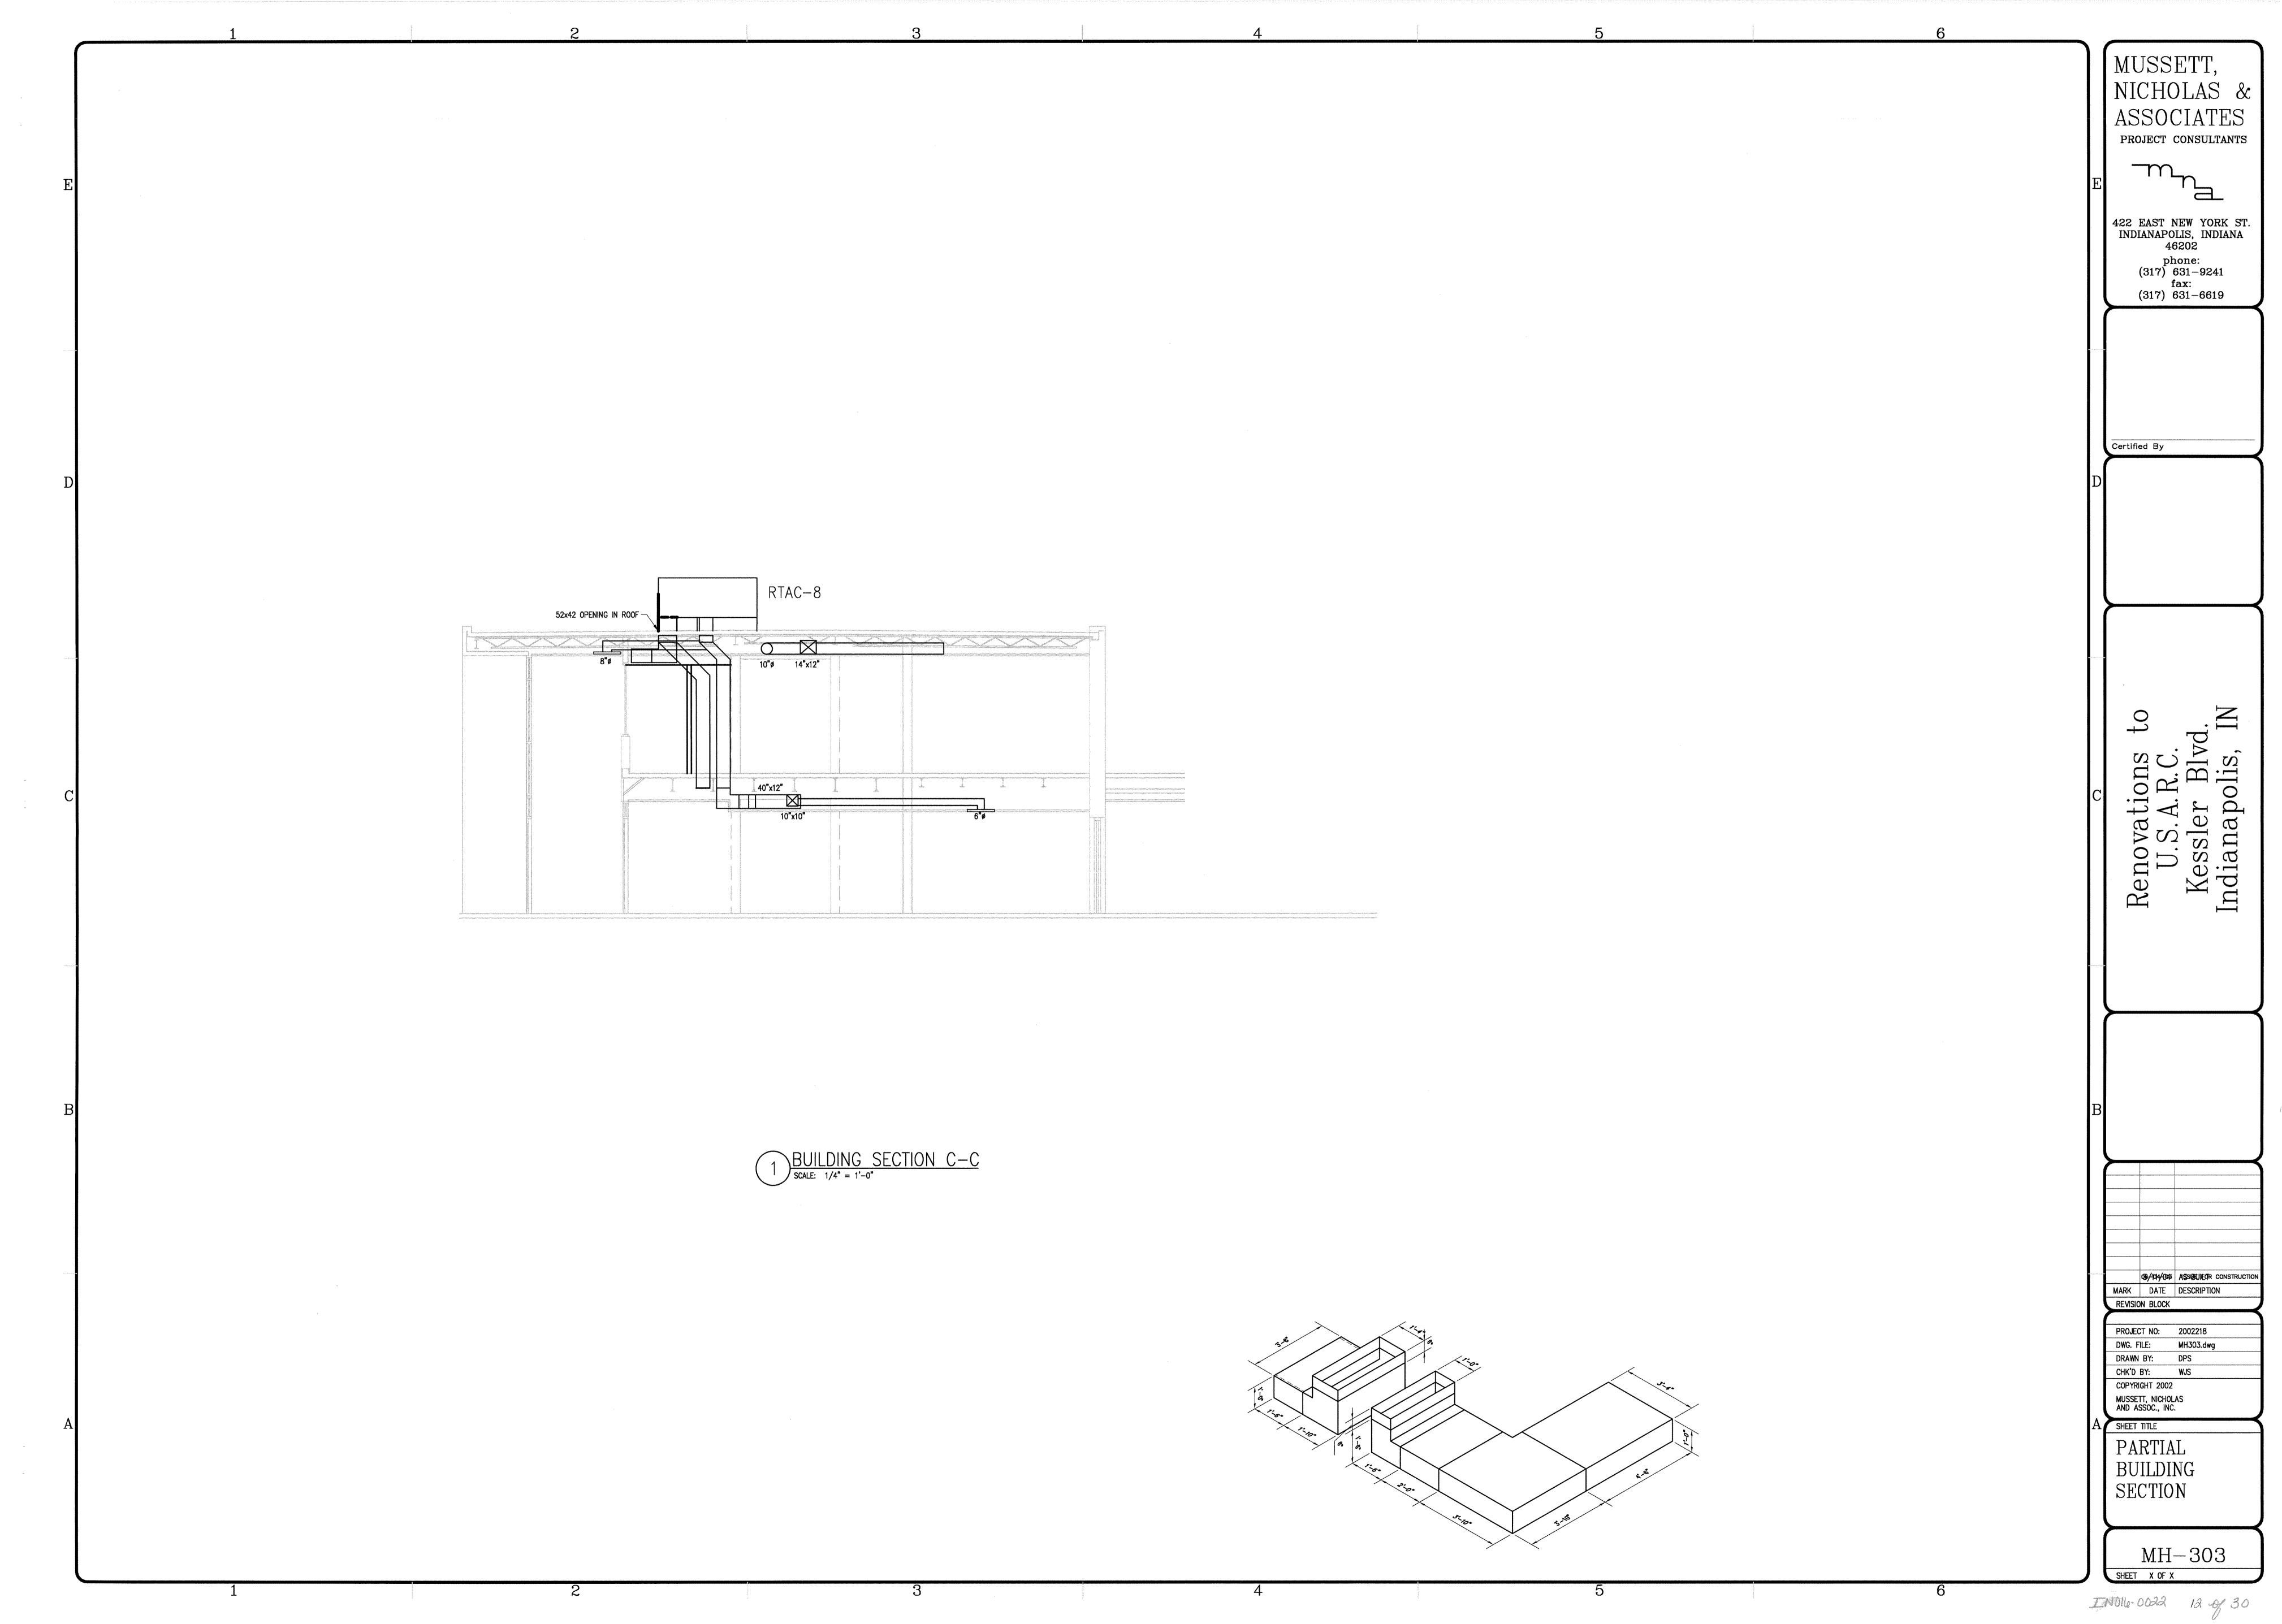


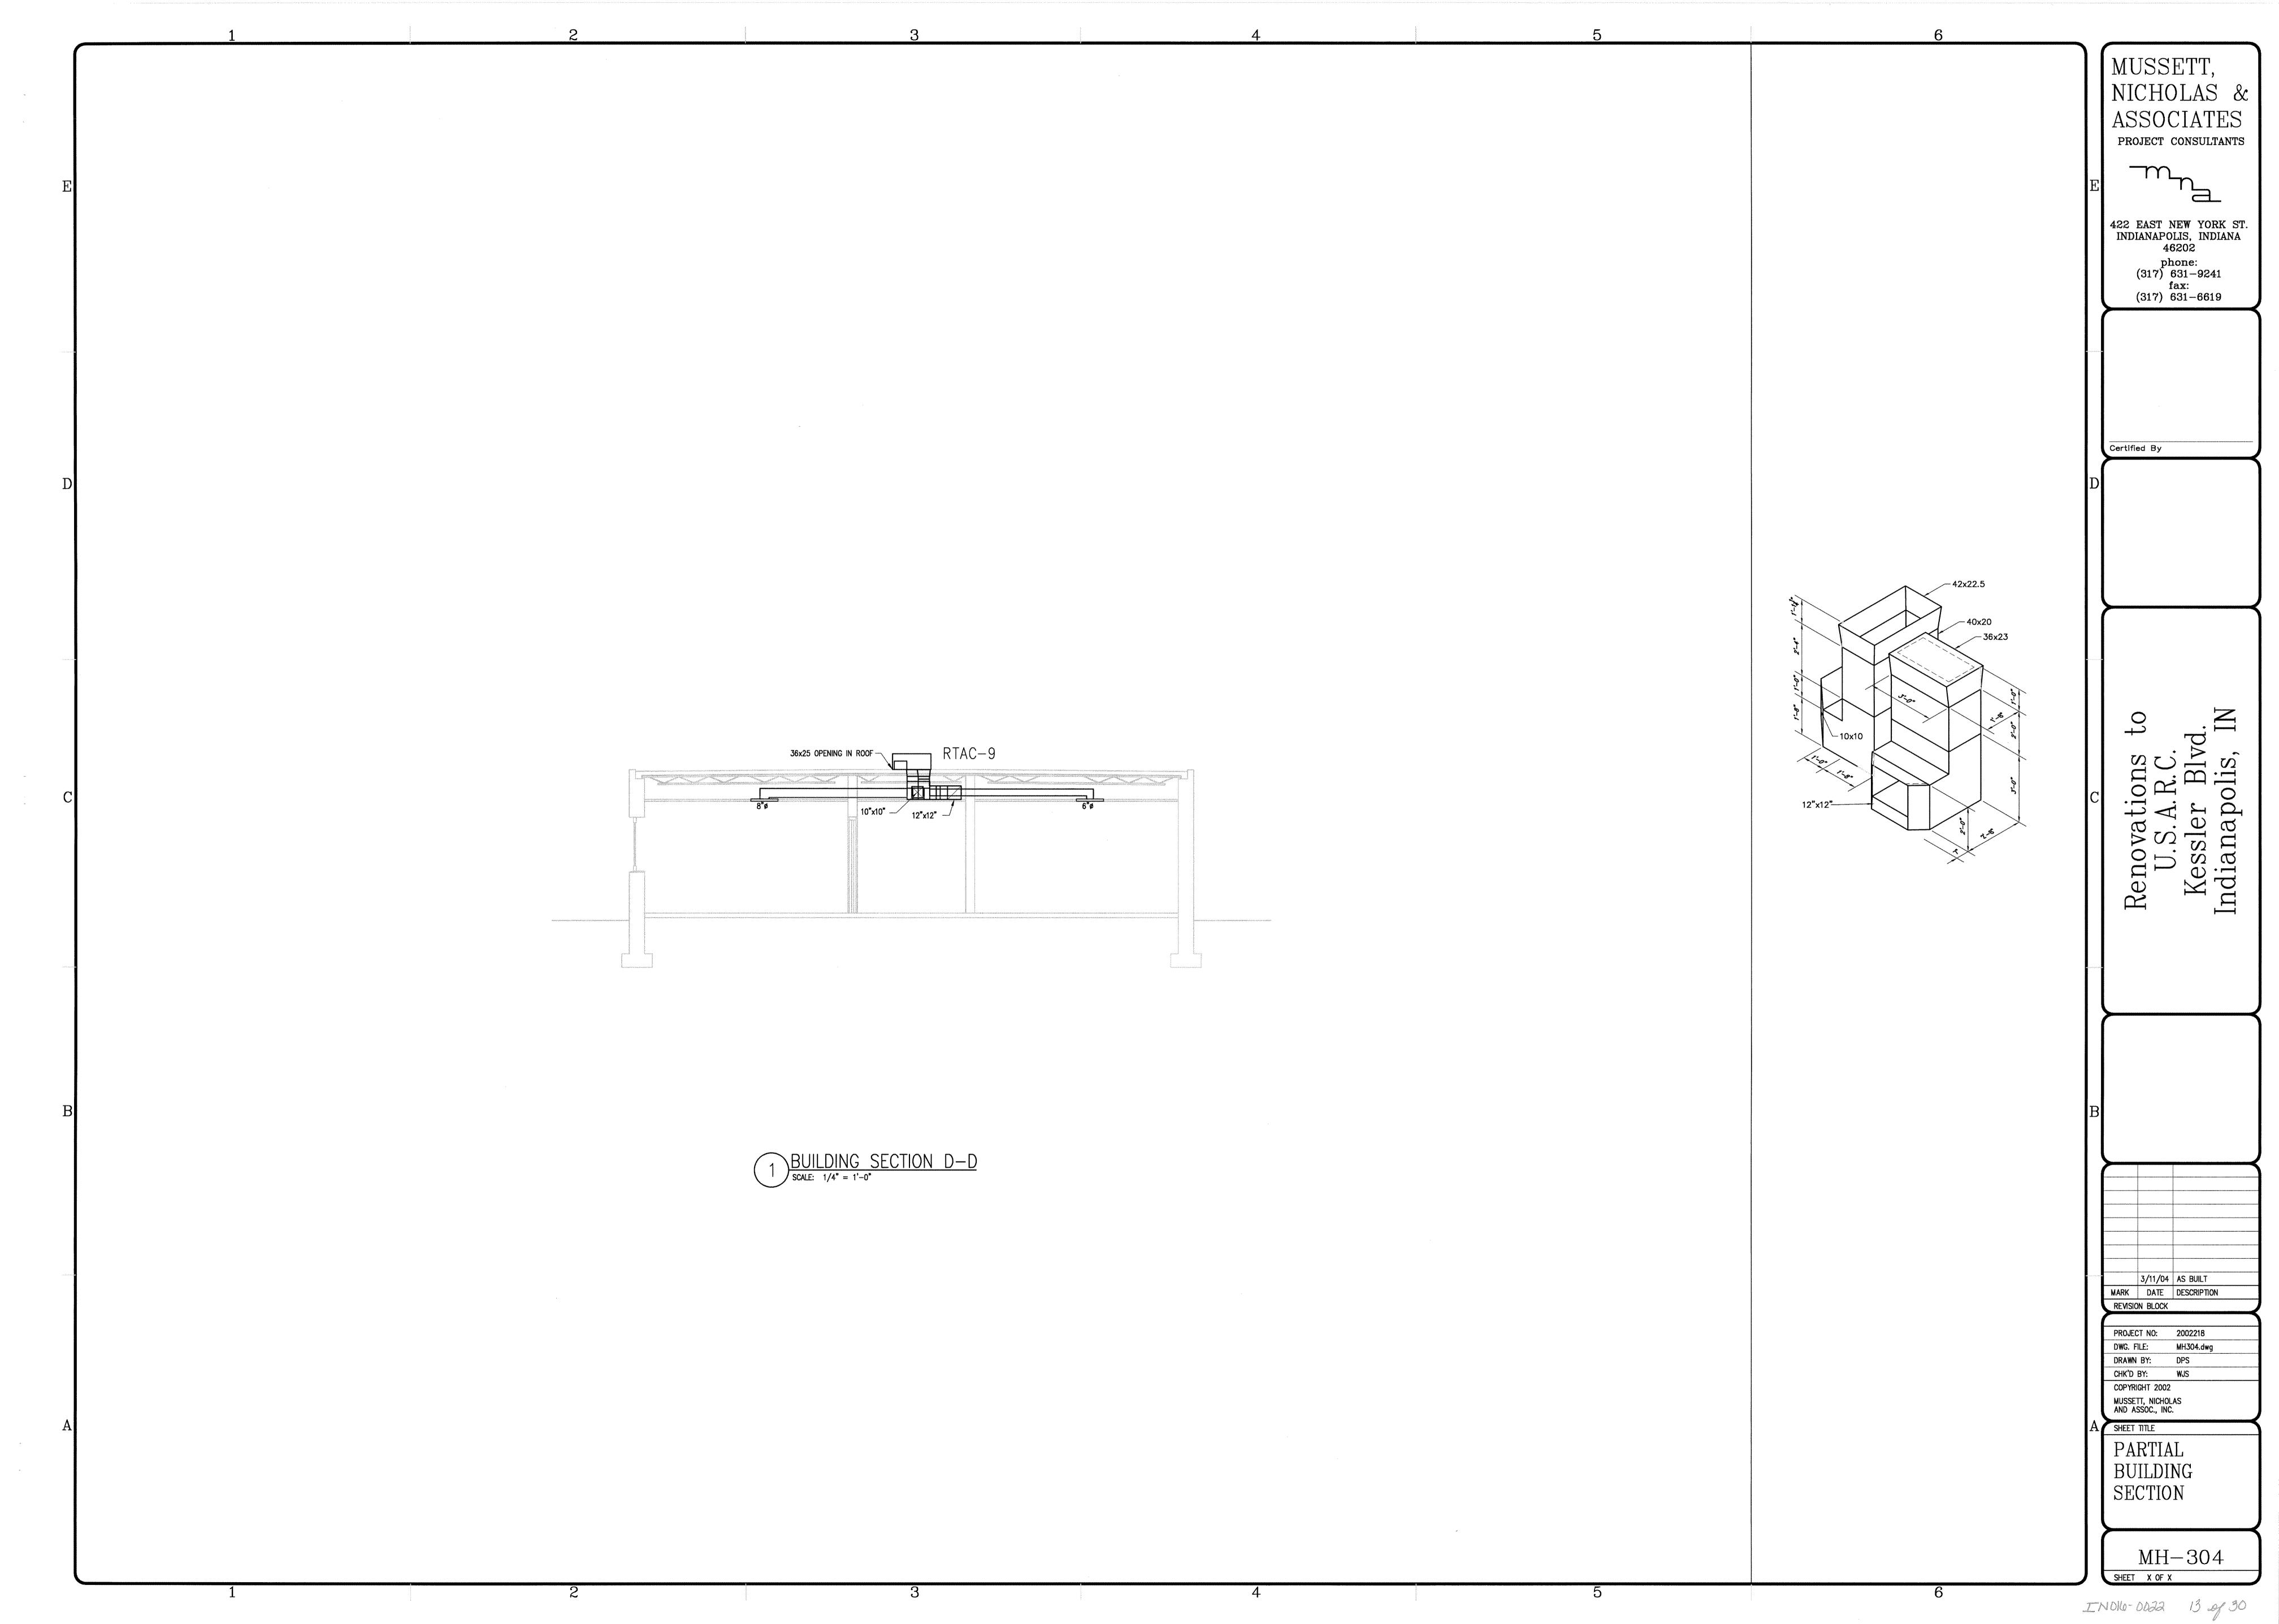


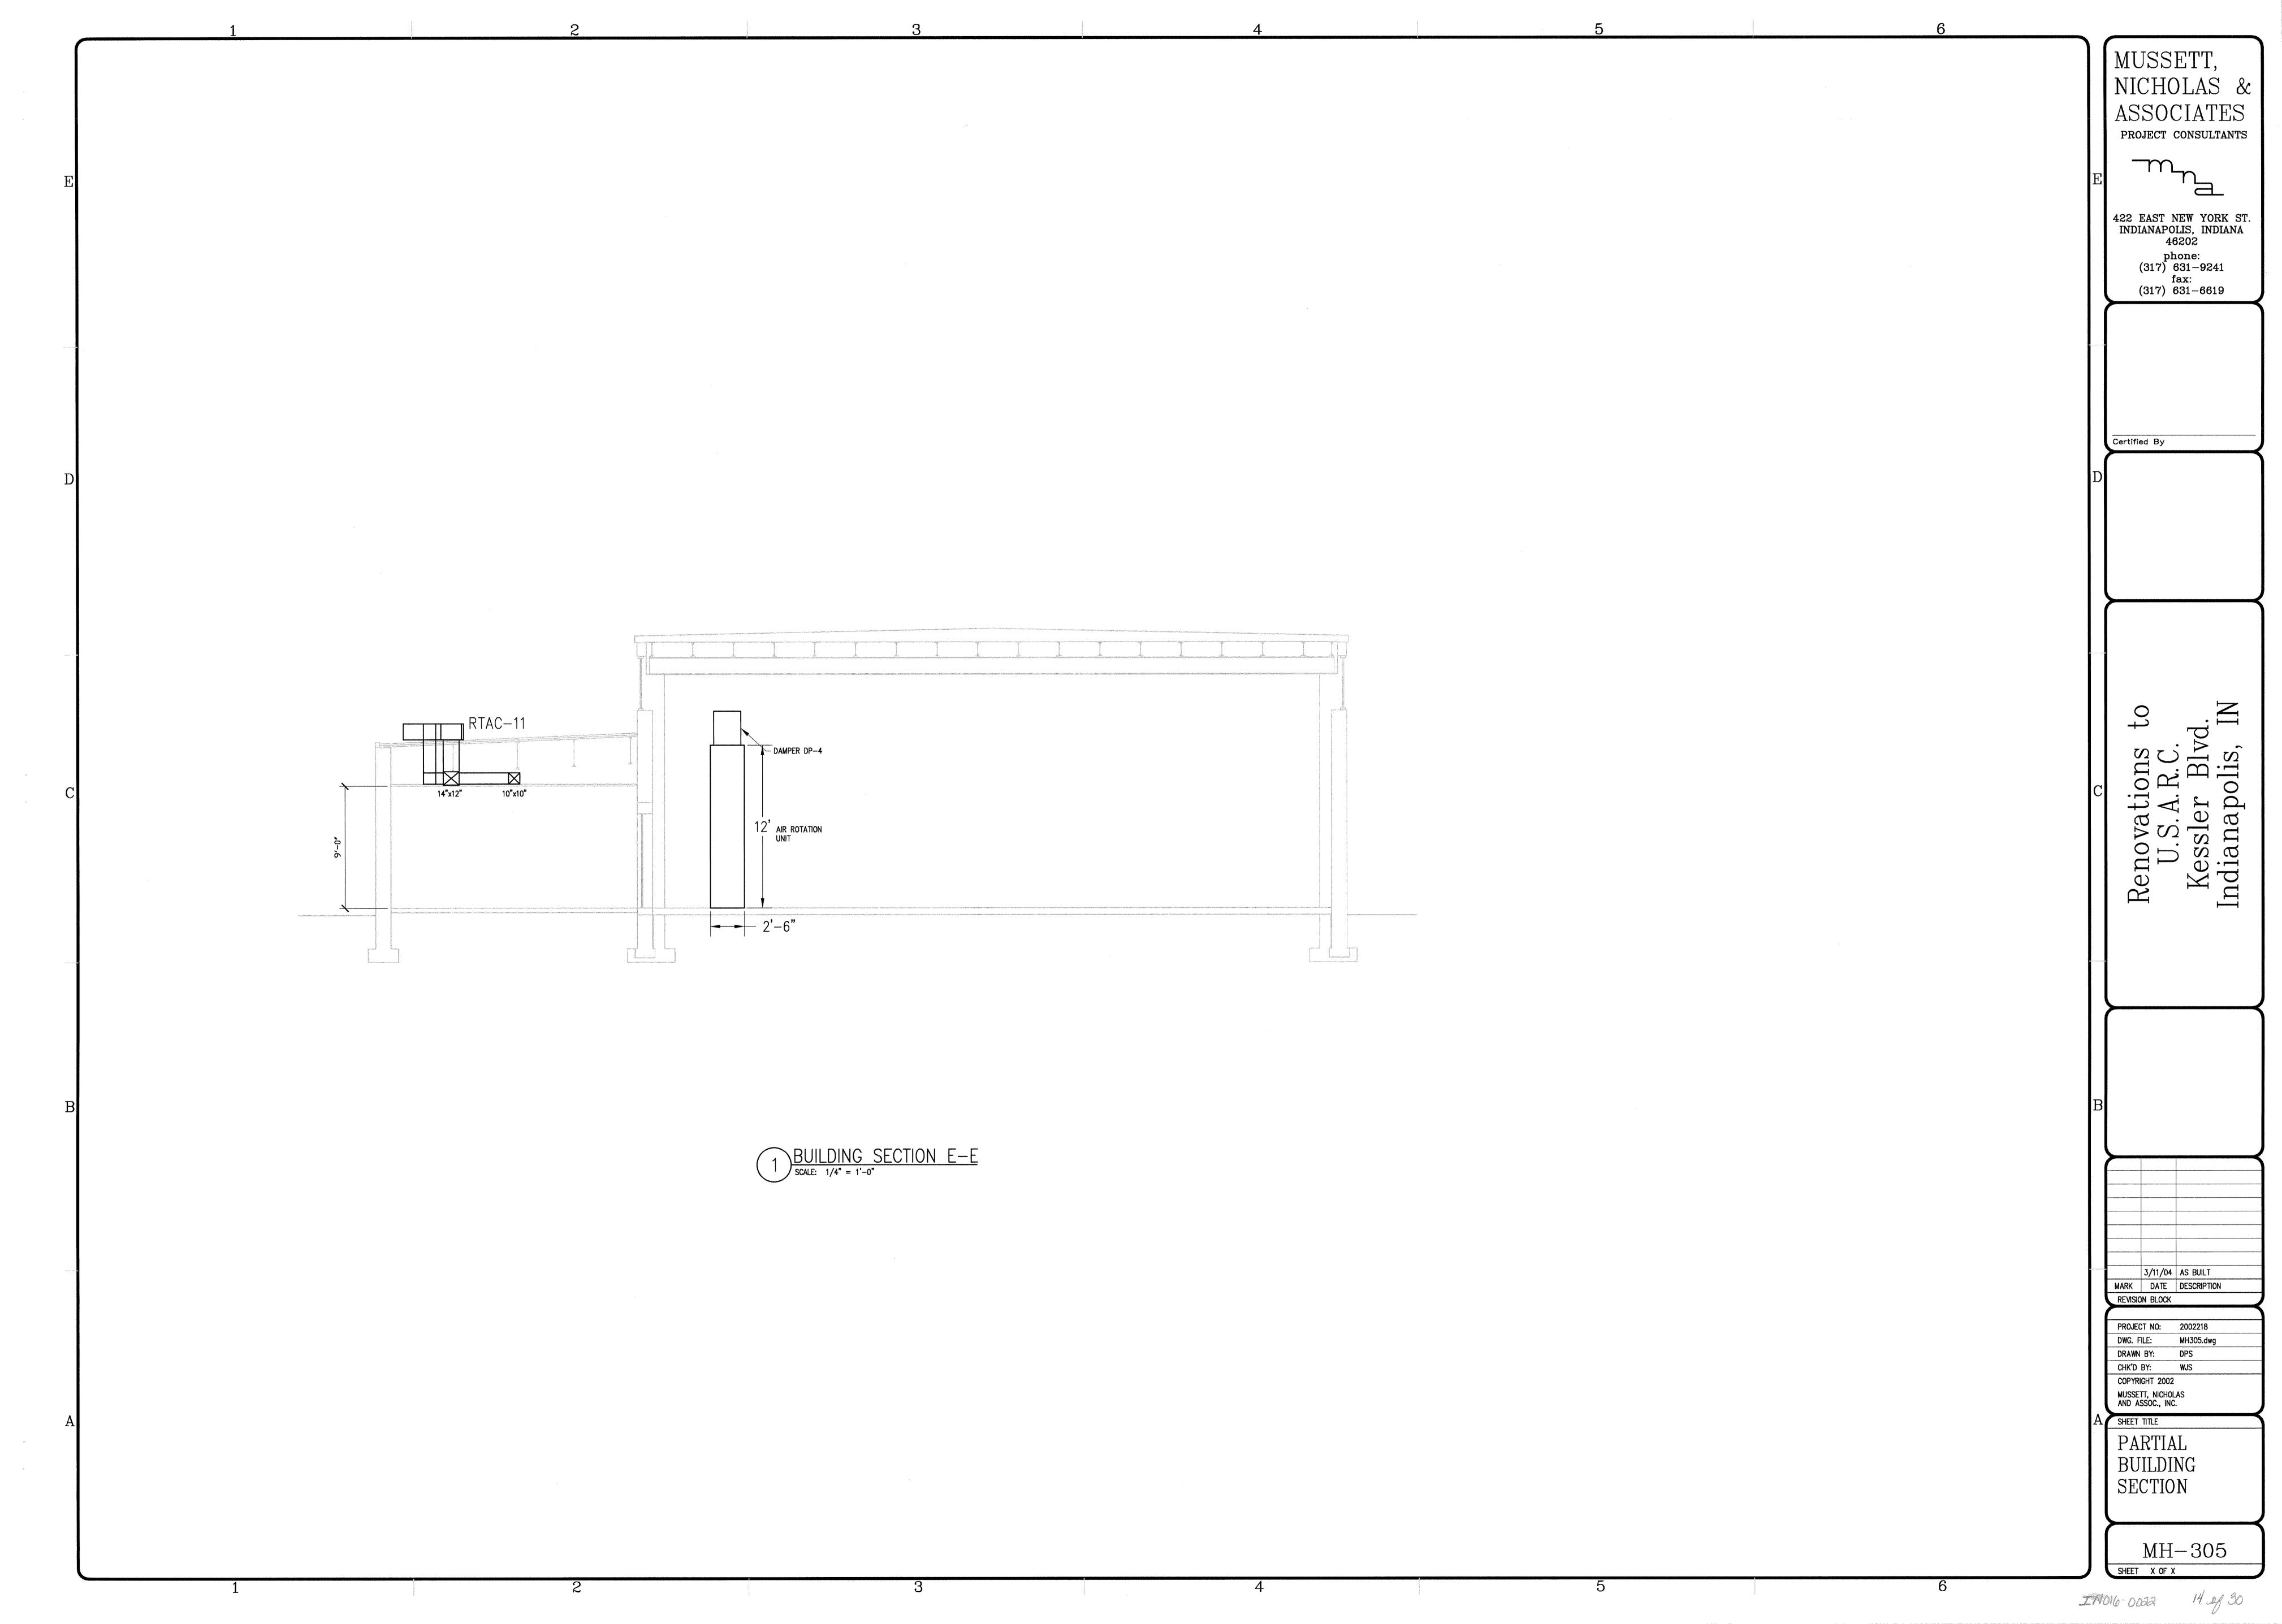

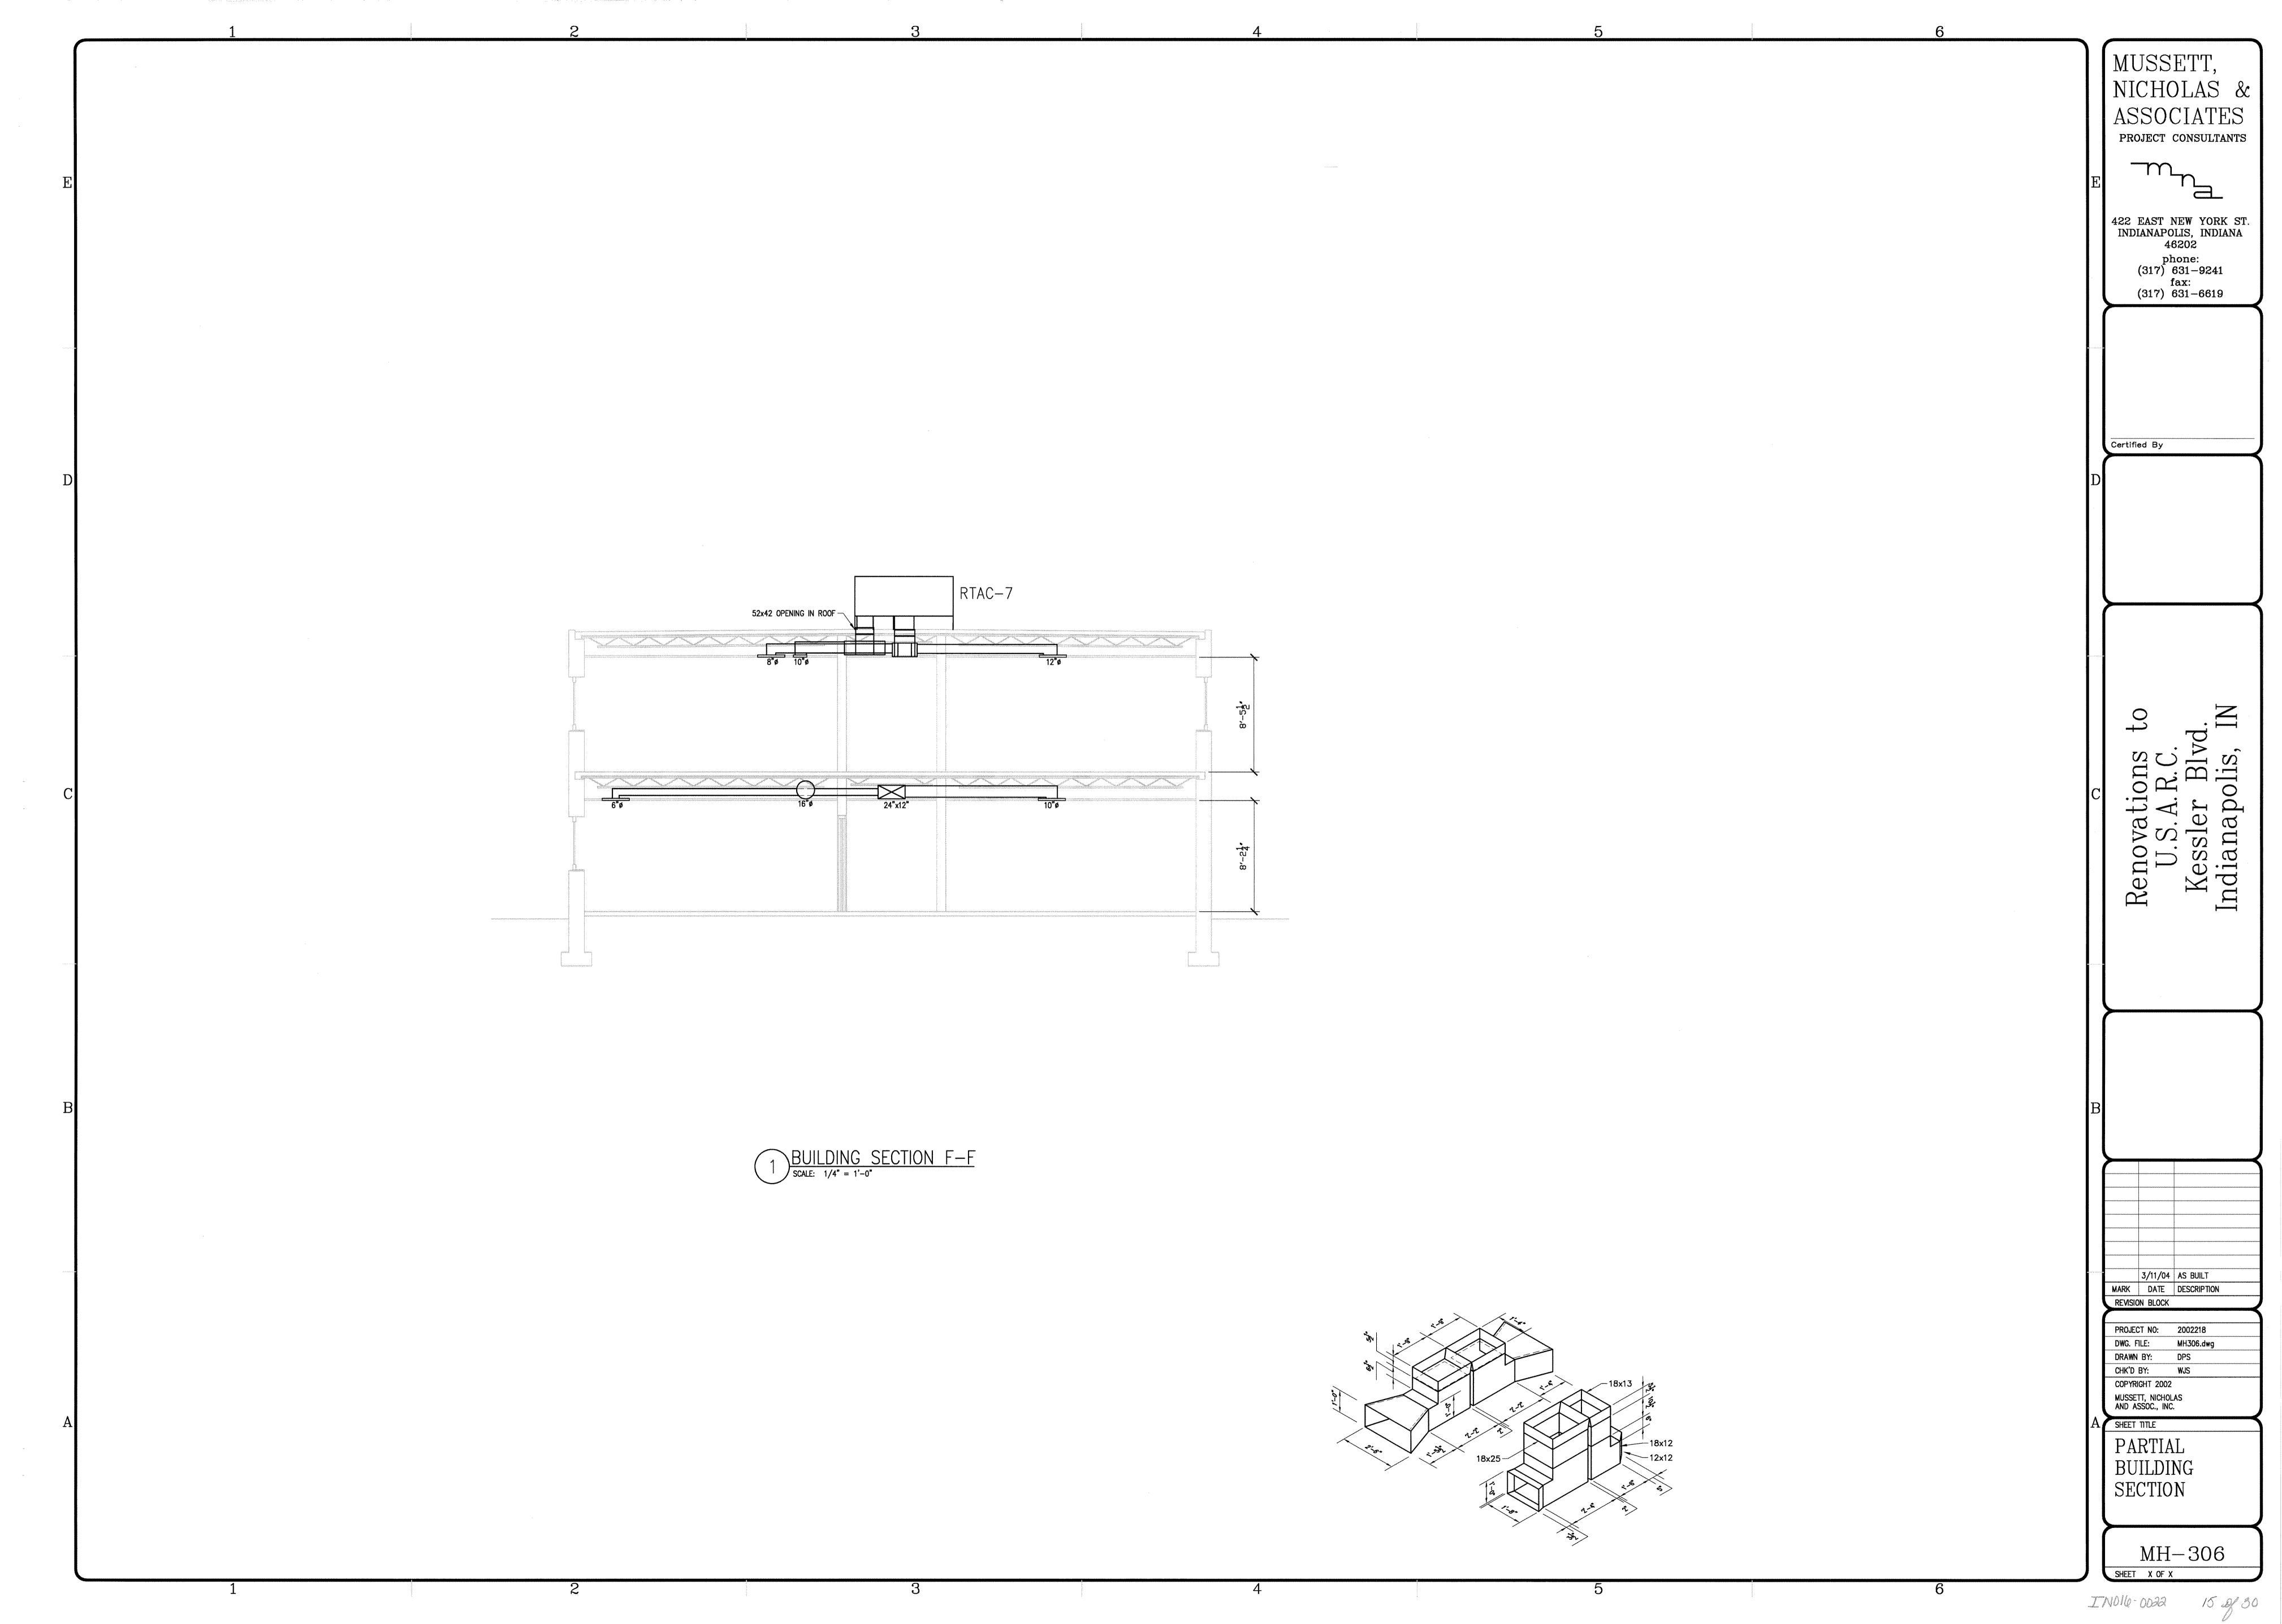

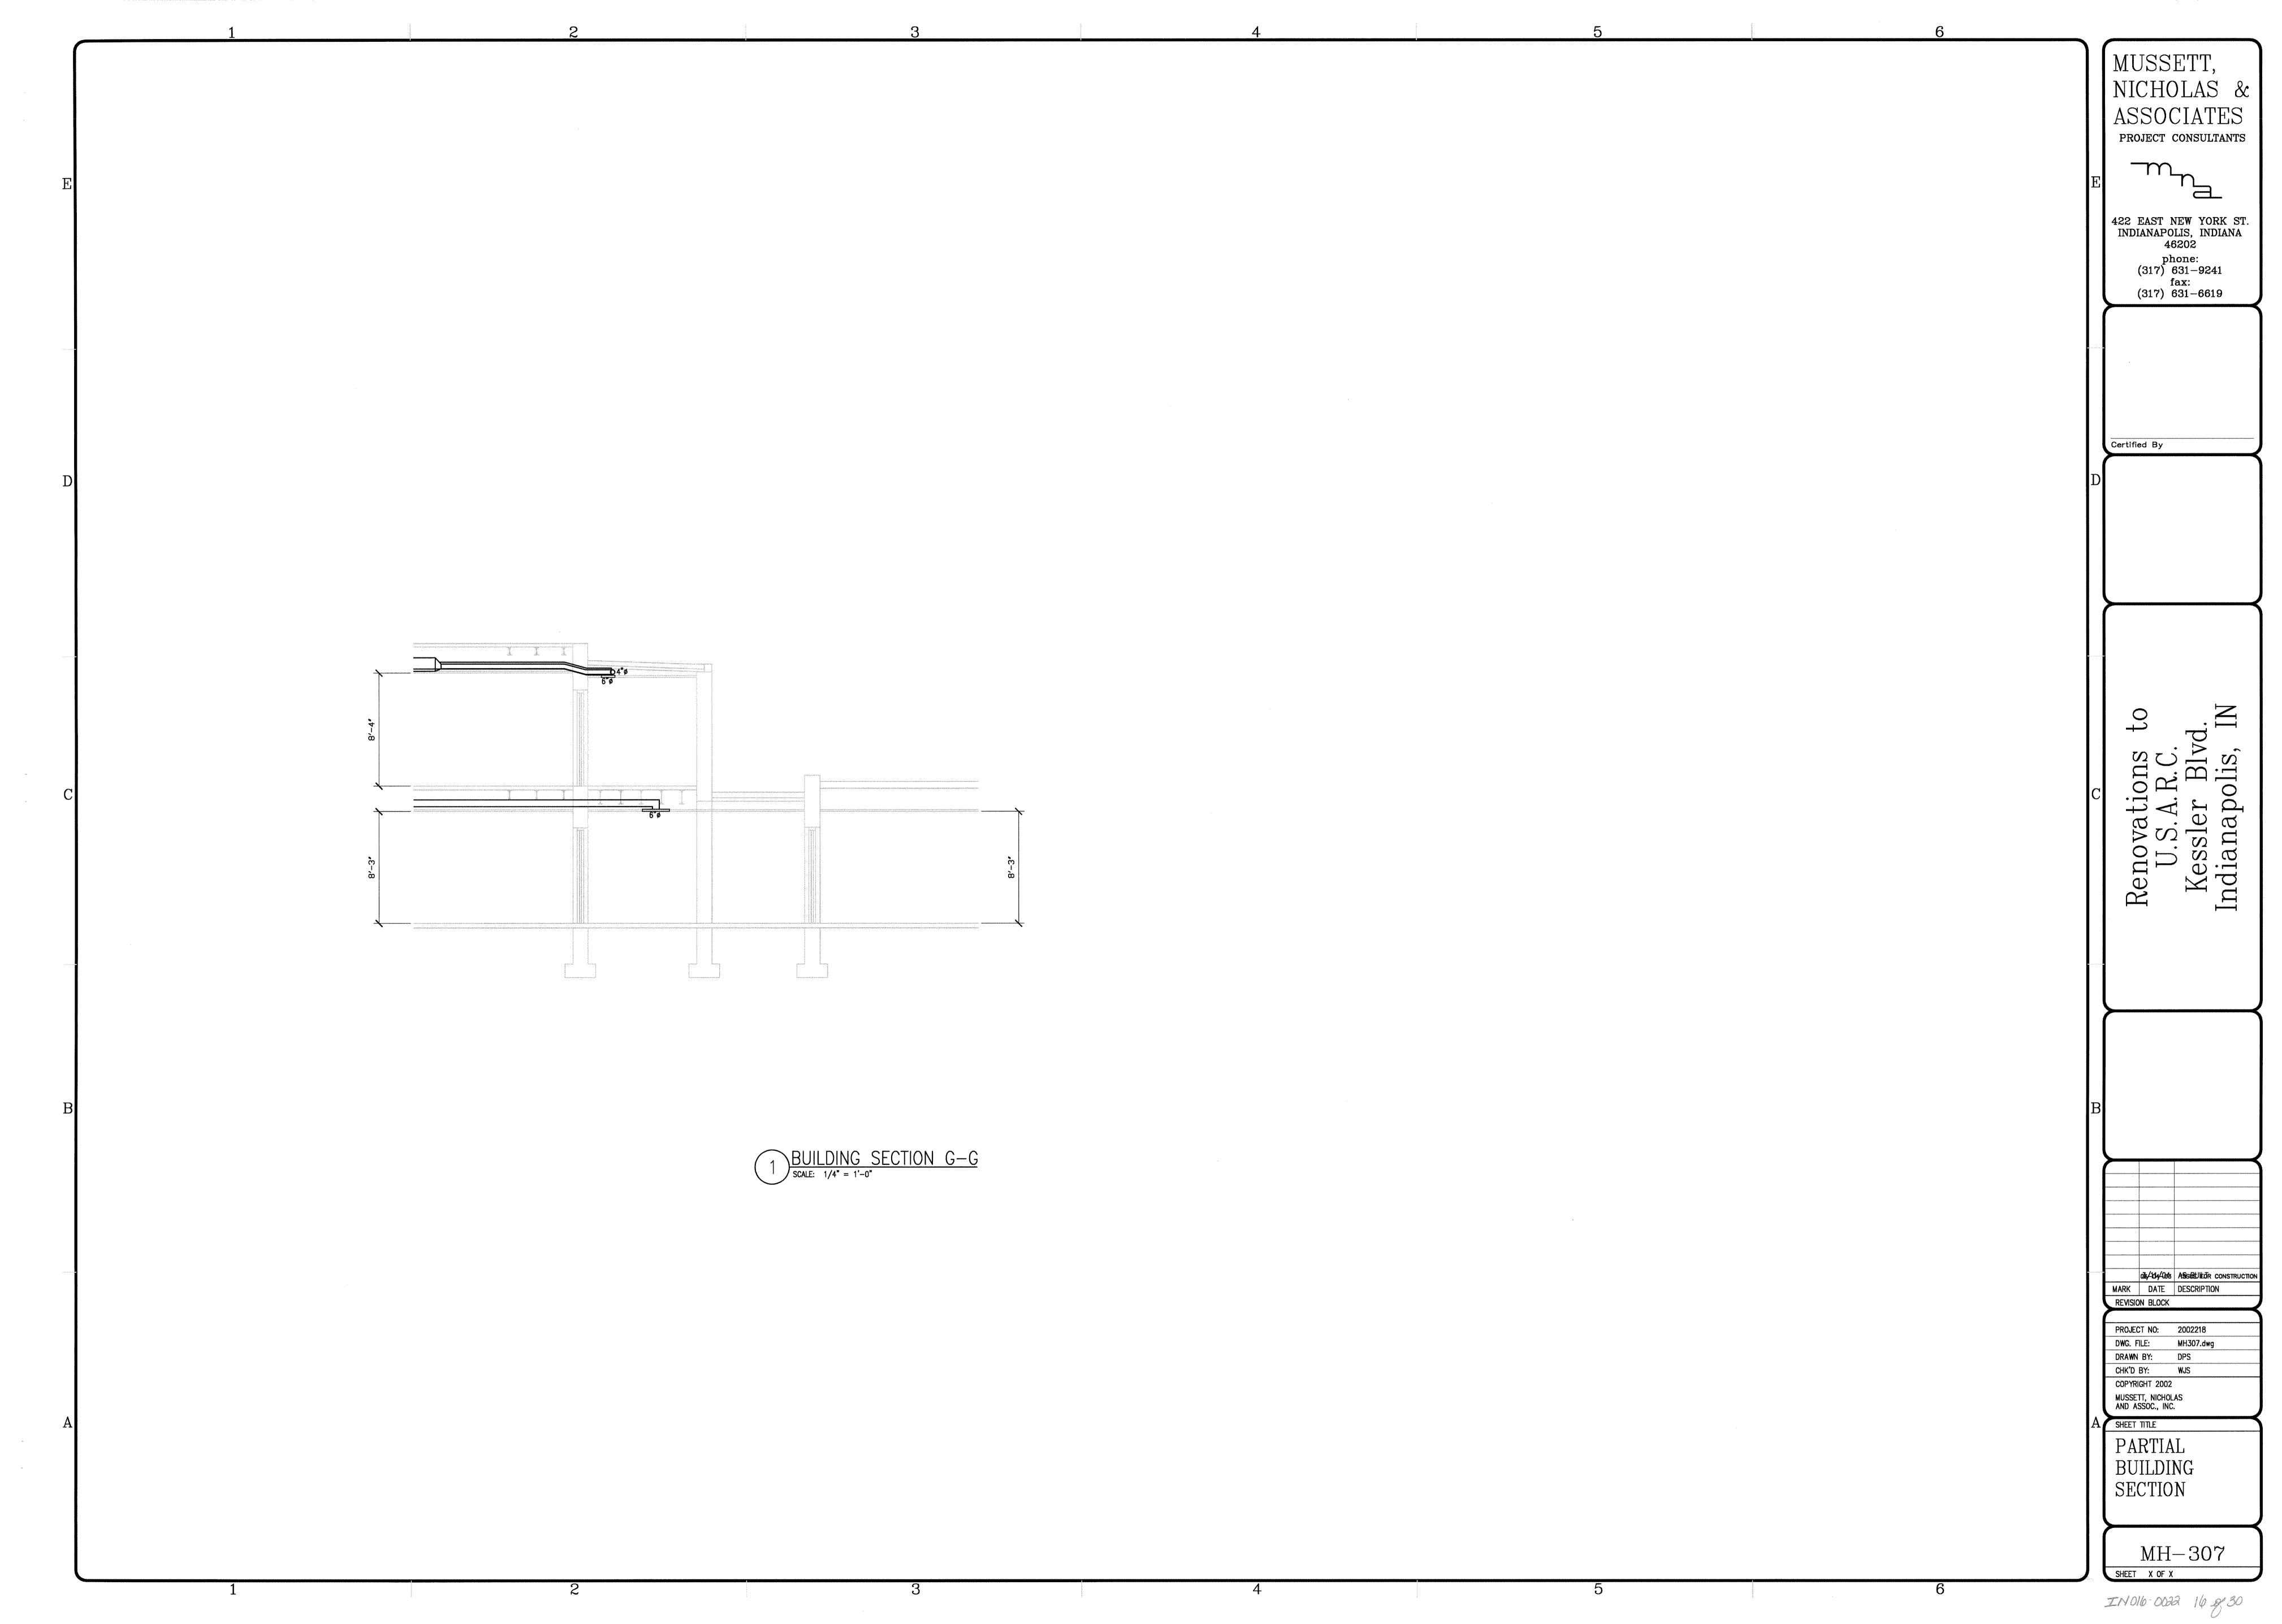

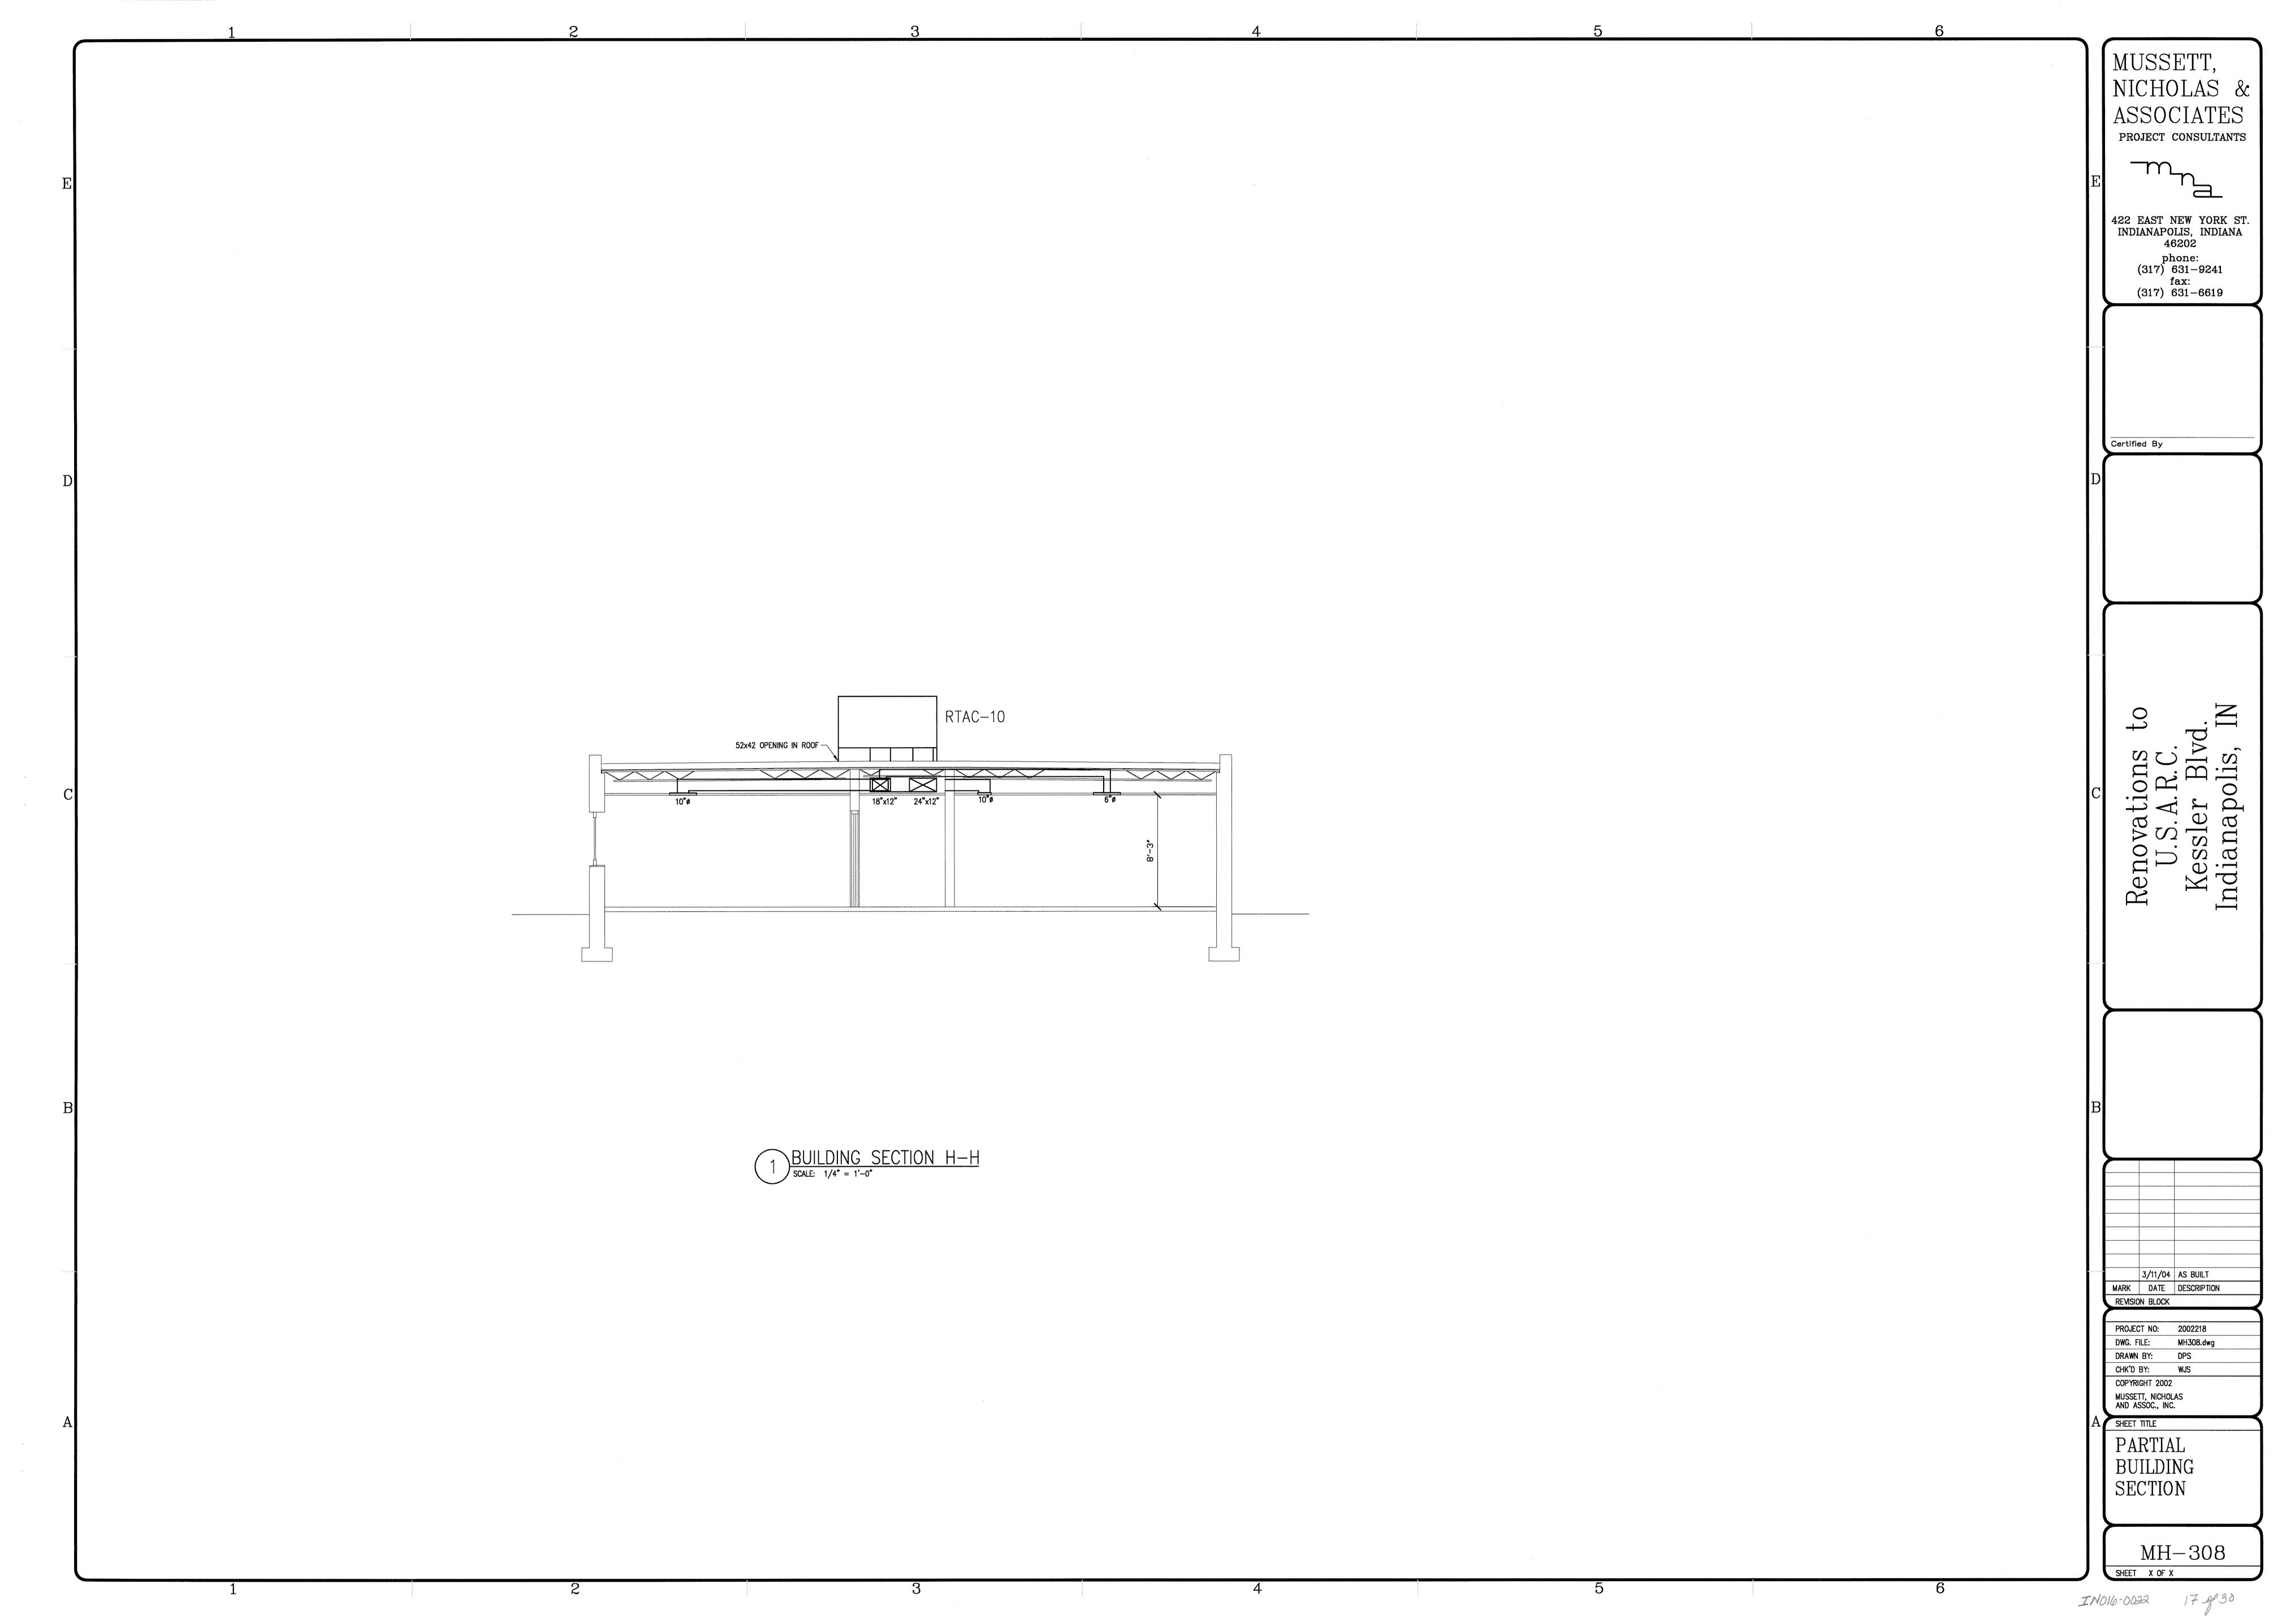

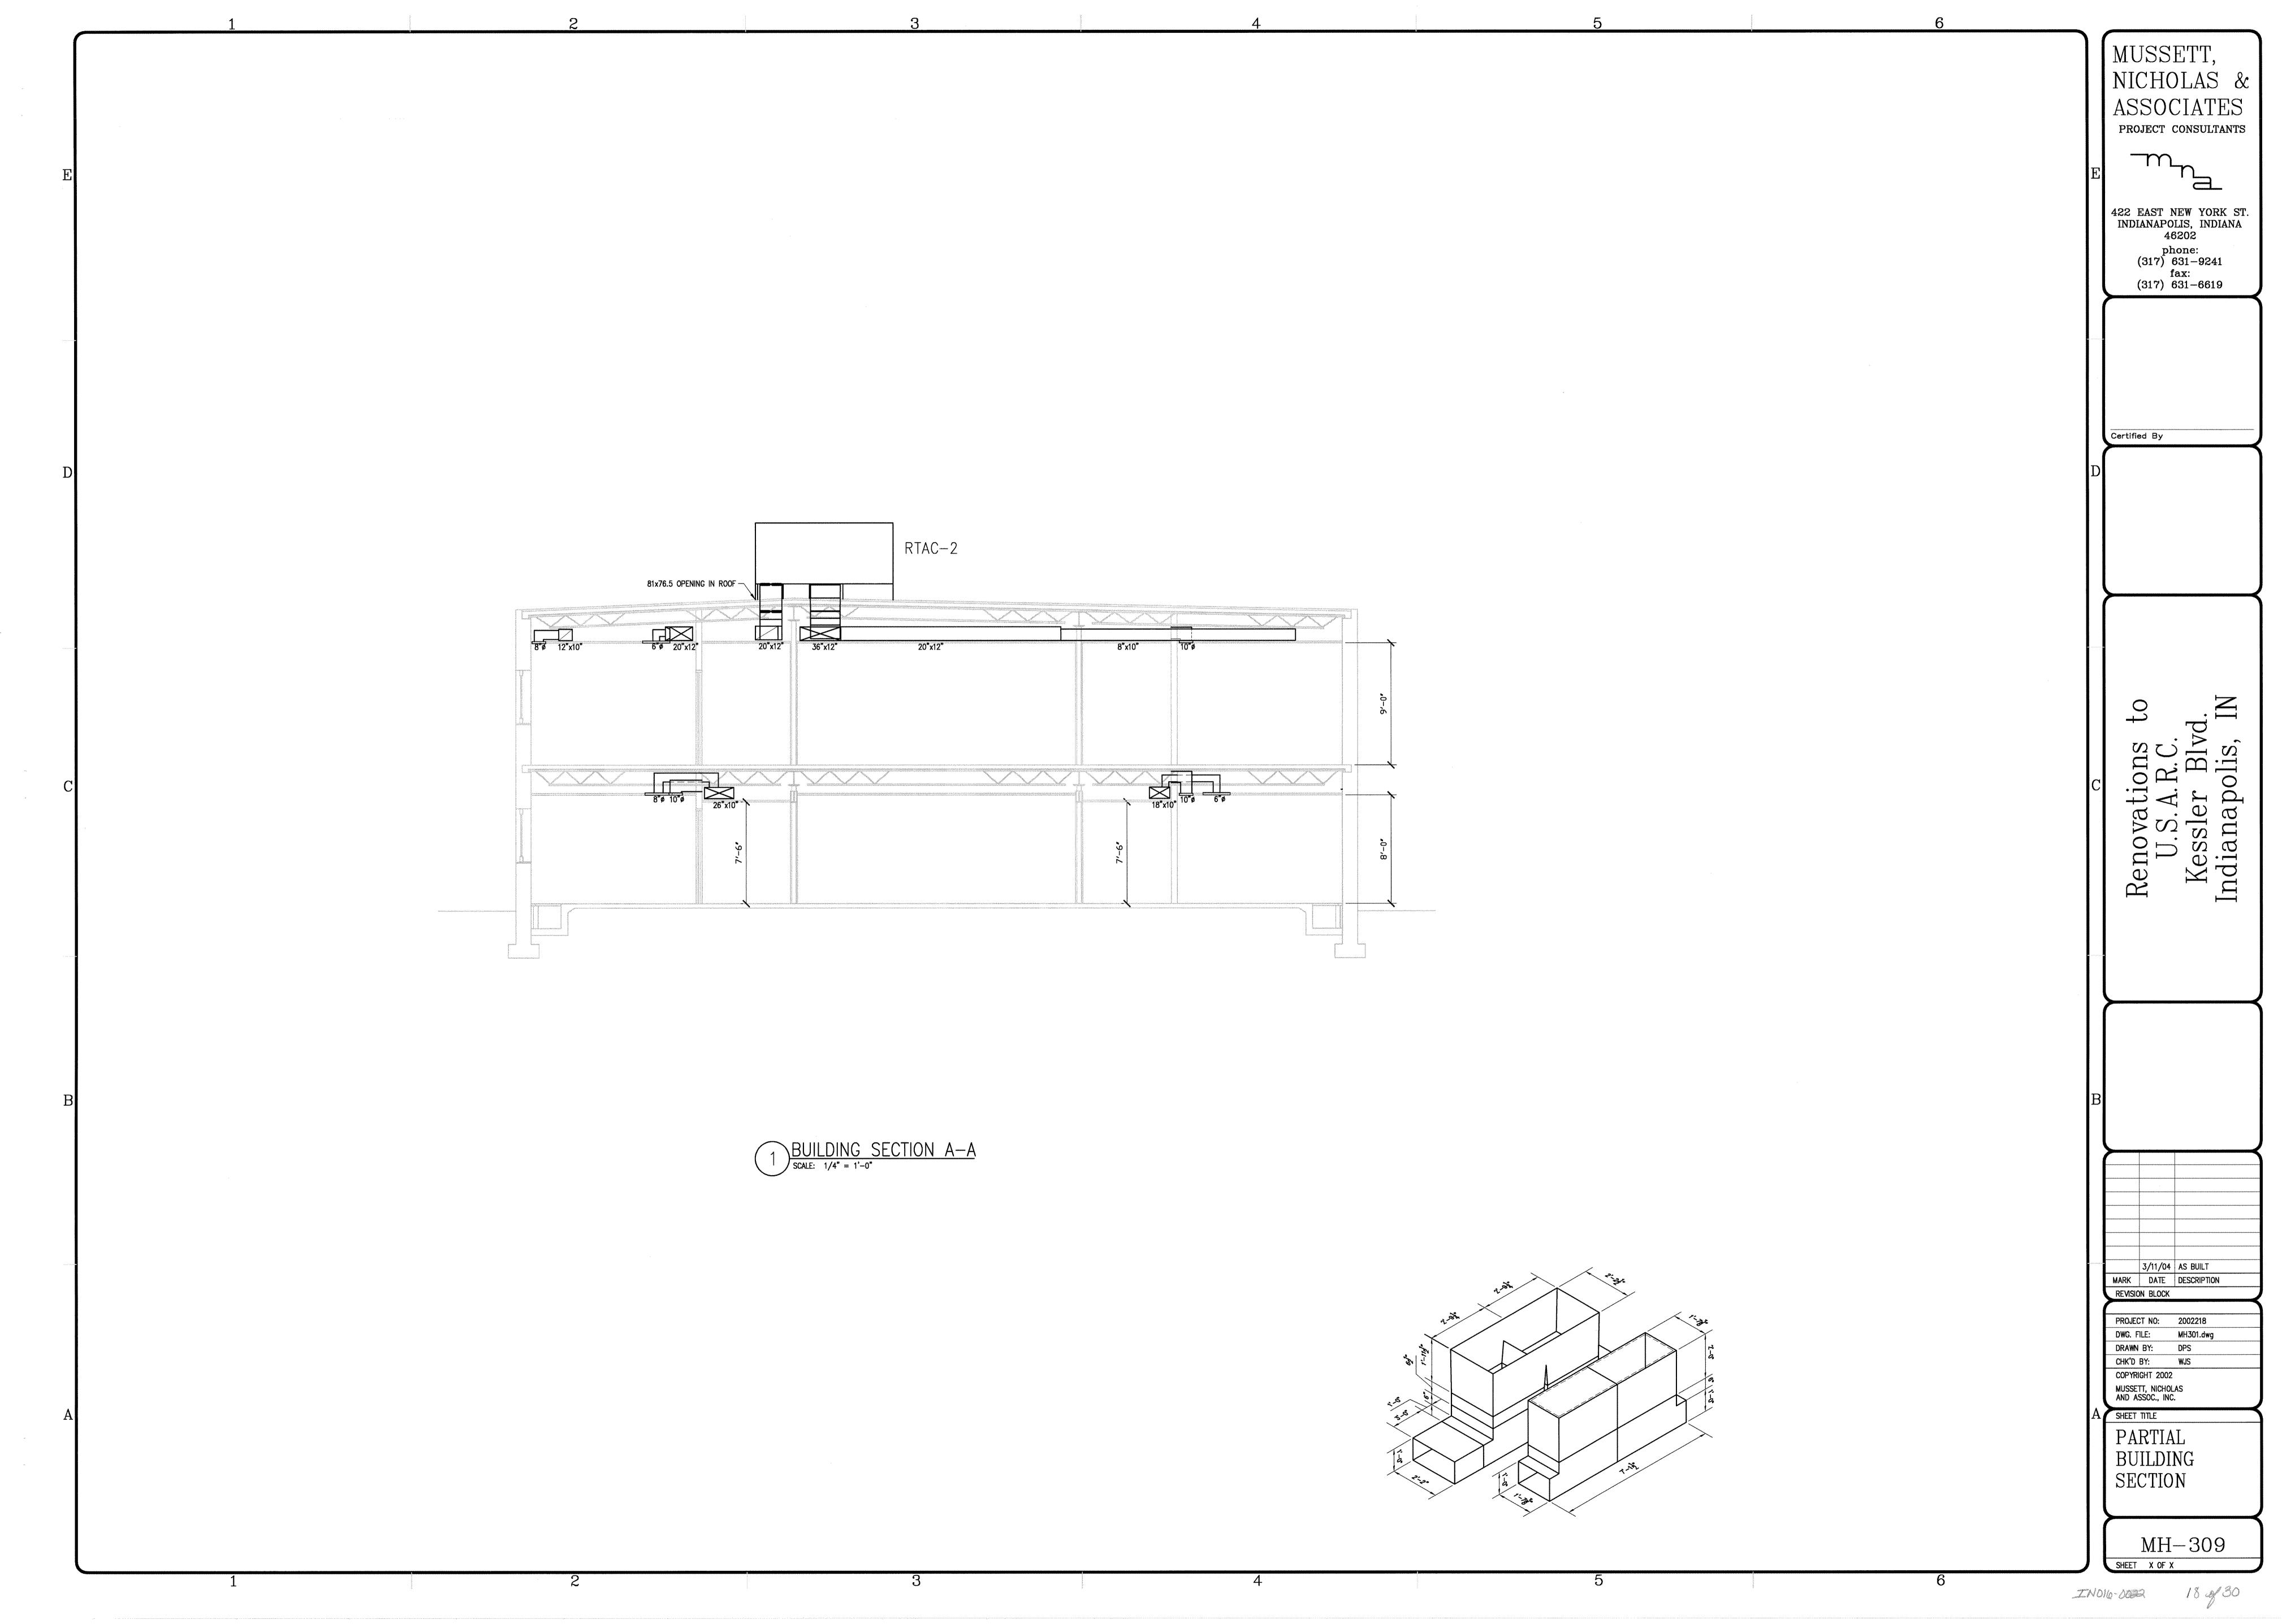

ROOFTOP UNITS (GAS HEATED/ELECTRIC COOLED) RTAC-11 RTAC-1, RTAC-3, RTAC-4 RTAC-5, RTAC-6, RTAC-10 RTAC-7, RTAC-8 RTAC-9 MARK NO. SERVICE LOCATION ROOFTOP ROOFTOP ROOFTOP ROOFTOP ROOFTOP ROOFTOP TRANE YC210C3 TRANE YC075C3 TRANE YC120C3 TRANE YC090D3 TRANE YCC030F1L0B TRANE YCC018F1L0B MODEL 208-230/3/60 208-230/3/60 208-230/3/60 208-230/3/60 208-230/1/60 208-230/1/60 VOLTZ/HERTZ/PHASES 18000 210000 101000 90000 INDOOR AIRFLOW (CFM) 7000 3400 3000 1000 600 175000 135000 120000 50000 120000 INPUT BTUH عنا 30/75 30/75 30/75 30/60 30/60 TEMP. RISE 'F (MIN/MAX) 30/75 **光 TYPE OF GAS** NATURAL NATURAL NATURAL NATURAL NATURAL NATURAL ≟ ≥ NO. USED NOLTZ/HERTZ/PHASES 208-230/60/3 208-230/60/3 208-230/60/3 208/60/1 208-230/60/3 PLATE FIN PLATE FIN PLATE FIN PLATE FIN PLATE FIN PLATE FIN ROWS 3/16 2/16 2/16 2/15 2/15 FACE AREA 7.00 27.12 16.03 14.00 5.43 4.5 3/8 .375 TUBE SIZE PROPELLER PROPELLER PROPELLER PROPELLER PROPELLER 2/26 1/24 1/18 ₹ ≤ NO. USED 1/24 1/26 1/.50 1/.2 1/.2 1125 1125 1080 208/1/60 208-230/3/60 208-230/3/60 208-230/3/60 208-230/3/60 208/1/60 S VOLTZ/PHASE/HERTZ 3.4 3.4 5.5 F.L. AMPS DRIVE HP BELT BELT BELT BELT DIRECT DIRECT 208/1/60 8 VOLTZ/HERTZ/PHASES 208/1/60 208-230/3/60 208-230/3/60 208-230/3/60 208-230/3/60 16.7 <sup>5</sup> SI F.L. AMPS 5.9 R-22 R-22 R-22 R-22 R-22 R-22 21.0 7.1/CIRCUIT 4.4 3.8 GAS PIPE SIZE SHIPPING WEIGHT GAS PRESSURE YES YES YES YES YES ECONOMIZER OPTION 13.2 13.2 UNIT AMPACITY MAX FUSE PROGRAMMABLE PROGRAMMABLE PROGRAMMABLE PROGRAMMABLE PROGRAMMABLE OPTIONS: PROGRAMMABLE THERMOSTAT THERMOSTAT THERMOSTAT THERMOSTAT THERMOSTAT THERMOSTAT

MARK NO.	EH-2, EH-4, EH-5, EH-9,	EH-1, EH-3, EH-7, EH-1
	EH-10	EH-11, EH-12
NAME		v
MANUFACTURER/MODEL	TRANE	TRANE
LOCATION	ENTRANCES	ENTRANCES
SERVICE		
VOLTZ @ 60HZ	208	208
PHASE	1	1
WATTS	3000	2000
AMPS	10.8	8.2/4.2
SHIPPING WEIGHT	22 LBS	13 lbs
BTUH	10,287	6,826/3,413
OPTIONS		

5.8

PROPELLOR UNIT H	PROPELLOR UNIT HEATER		
MARK NO.	PUH-1		
NAME	SEPERATED COMBUSTION		
MANUFACTURER/MODEL	TRANE/GAND-0.10		
LOCATION	MECHANICAL ROOM		
SERVICE	MECHANICAL ROOM		
INPUT MBH	100		
OUTPUT MBH	80		
FLUE OUTLET	4"		
CFM	1400		
TEMP. RISE T	50		
OUTLET VELOCITY	775		
NOMINAL HORSEPOWER	1/20		

MOTOR FLA @ 120

COMBUSTION AIR DUCT

SERVICE LOCATION DRIVE TYPE AIRFLOW (CFM) TOTAL SP (IN WC)	EXHAUST DRILL HALL DIRECT DRIVE 5450
DRIVE TYPE AIRFLOW (CFM)	DIRECT DRIVE
AIRFLOW (CFM)	
	5450
TOTAL SP (IN WC)	
	0.5
FAN RPM	1760
PROPELLER DIA(IN)	24
TIP SPEED (FPM)	
BHP	1.07
MOTOR HORSEPOWER	1
VOLT/PH/HZ	208/3/60
MOTOR CONTROLLER	
MFR	NEW YORK BLOWER
MODEL	EF24
REFERENCE PLAN	
REMARKS	
	TIP SPEED (FPM) BHP MOTOR HORSEPOWER VOLT/PH/HZ MOTOR CONTROLLER MFR  MODEL  REFERENCE PLAN

DAMPER SCHEDULE (CONTINUED)

MARK NO.

LOCATION

HEIGHT

AIR VELOCITY

WEIGHT IN LBS REMARKS

MANUFACTURER

1	AIR ROTATION UNIT		
MARK NO.		AR-1	
NAME			
MANUFACTURER/MODEL		APPLIED AIR	
LOCATION		DRILL HALL	
SERVICE		GENERAL HEATING	
	INPUT (MBH)	250	
FUEL	REQUIRED PRESSURE		
	PIPING CONNECTION	3/4"	
٩L	VOLTZ/HERTZ/PHASE	115V/60HZ/1 PHASE	
ELECTRICAL	FULL LOAD AMPS	7.0	
ECT	MIN CIRCUIT AMPACITY		
ᆸ	MAX FUSE SIZE		
HP		.5	
REMARKS		8" FLUE CONNECTION	
	HEATING CFM	5500	
	SHIPPING WEIGHT		
	OPTIONS:	MANUFACTURER SUPPLIED	
		DISCHARGE PLENUM	
		10 YEAR HEAT	
		EXCHANGER WARRENTY	
		FACTORY SUPPLIED	
		AND MOUNTED CONTROLS	
		FLOOR MOUNTED	
		FRAME	
		ADDITIONAL GAS	
		PRESSURE REGULATOR	

DP-1, DP-2 & DP-4

SUPPLY DAMPER

AMERICAN WARMING & VENT. VC-26

DRILL HALL

1000FPM

AUTOMATIC ACTUATOR

120V OPERATION

L-1 & L-2

SUPPLY LOUVER

AMERICAN WARMING & VENT.

LE-23

DRILL HALL

DP-3

SUPPLY DAMPER

AMERICAN WARMING & VENT.

VC-26

DRILL HALL

1000FPM


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AUTOMATIC ACTUATOR

120V OPERATION


RAIN CAP		
3' ABOVE HIGHEST ROOF POINT ROOF FLASHING UNISTRUT CHANNEL  FUEL GAS VENT SEE SPECIFICATIONS FOR TYPE	DOUBLE WALL FLUE (LIKE METALBESTOS 'PS')	4" X 4" X 18" TREATED WOOD  2" X 12" X 24"
1/2" THREADED ROD	AIR GAP FOR VENTILATION— THIMBLE	TREATED WOOD SAND BOTTOM EDGES SMOOTH
GAS PIPE BRANCH (SEE PLANS FOR SIZE)	THIMBLE COUNTER-FLASHING  SPACERS  ROOFING OR MEMBRANE  ROOF CURB	ROOF MEMBRANE



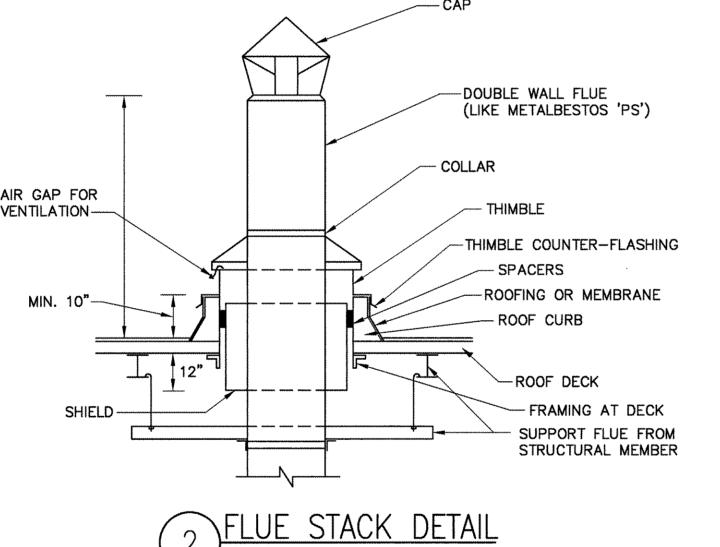

	U STRAP 1" LARGER THAN PIPE
2" X 12" X 24" TREATED WOOD SAND BOTTOM EDGES SMOOTH	BOLT
ROOF MEMBRANE	ROOFING MAT' PAD UNDER SUPPORT
	ROOF DECK —


NOTE: AN ACCEPTABLE ALTERNATIVE TO DETAIL IS TO PROVIDE MANUFACTURED PILLOW BLOCK PIPE STANDS SIMILAR TO MIRO MODEL 24 OR APPROVED EQUAL.

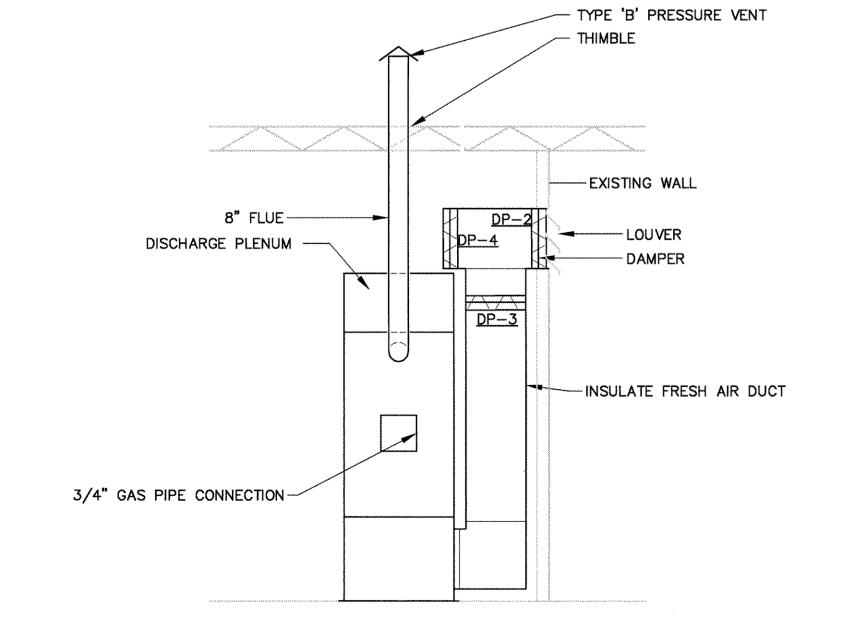

SHUT-OFF VALVE

TYPICAL PROPELLER UNIT HEATER GAS PIPING DETAILS


SCALE: N.T.S.

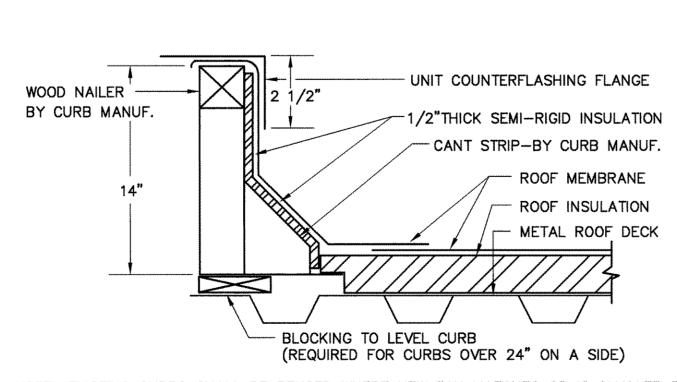

NOTE: EXISTING CURBS SHALL BE REUSED WHERE NEW FAN MATCHES OR IS SMALLER THAN EXISTING OPENING. SEAL EXCESS OPENING WITH 16 GA. GALVANIZED SHEETMETAL AND 2"- 3PCF RIGID FIBERGLASS ROOF INSULATION.

5 ROOF CURB DETAIL

SCALE: N.T.S.

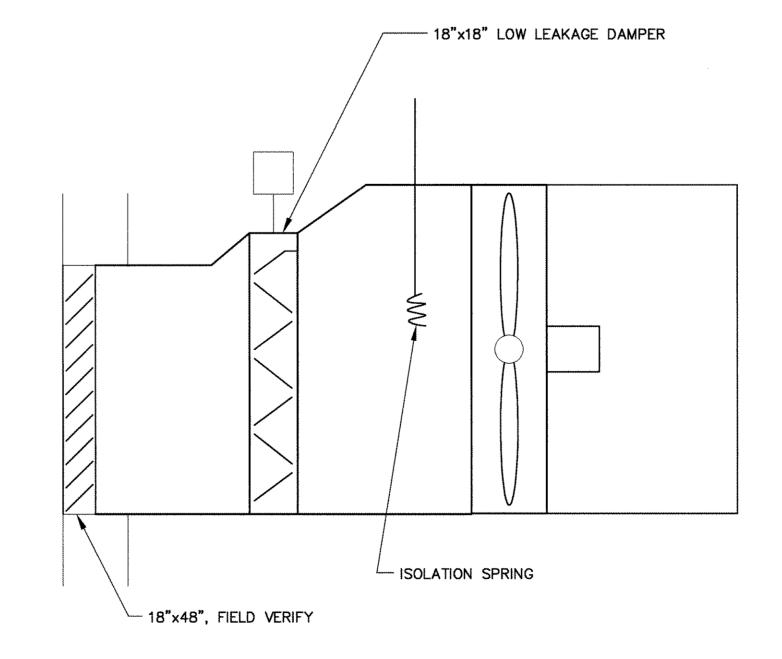

6 EXHAUST FAN FOR DRILL HALL SCALE: N.T.S.

4 AIR ROTATION UNIT SCALE: N.T.S.

SHEET X OF X

19 430

3/11/04 AS BUILT

MARK DATE DESCRIPTION

PROJECT NO: 2002218

DWG. FILE: MH600.dwg

SCHEDULES

AND DETAILS

MH - 600

DRAWN BY: DPS

CHK'D BY: WJS

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SHEET TITLE

MUSSETT, NICHOLAS AND ASSOC., INC.

REVISION BLOCK

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Certified By

INO/16-0022

